Lewis County Master Site Review



Community Development • 125 NW Chehalis Ave, Chehalis, WA 98532 • Phone: (360) 740-1146

Step 1 Site Analysis Status: CONDITIONALLY APPROVED

Parcel Number(s): 028513011000 Master Site Review #: MSR25-0118 Applicant's Name: NORTH GROUP, INC

Review #: 1

Project Proposal: Installation of a wireless communication facility consisting of a new 150' monopole with attached antennas and cabling along with ground mounted equipment cabinets and generator placed within a 50'x50 fenced area.

Associated Planning Permits: None Zoning: Rural Development District (RDD-5)

Conditions of Approval

- 1 Any change in the project from the current proposal requires further review.
- 2 All other required local, state, and federal permits are required to be obtained by the applicant including all permits listed on page two of this Master Site Review.
- 3 A Type III Wireless Communication Facility (WCF) Application is required.
- 4 The State Environmental Policy Act Checklist (SEPA) is required to be submitted with your WCF Application.
- 5 A Geotechnical Report is required for the proposal. The Geotechnical Report can be submitted with the WCF Application or be made a condition of approval of the WCF Application approval. The Geotechnical Report will need to include any improvements to the access road that are required for emergency services access.
- 6 A Stormwater Permit is required if the total amount of new impervious surface exceeds 5,000 square feet, including the access.

The recommendations and requirements in the following reports may be conditions of development: None

The current proposal is in compliance with the Critical Area Ordinance. If the project changes from the current scope, a review of the following critical areas may be required.

- Geologically Hazardous Areas Review due to the proximity of the site to steep slopes, erosion hazard areas and/or historic landslide areas.
- Geologically Hazardous Areas Review due to the proximity of the site to an Erosion Hazard Area

The following notices are provided for the proposal:

• The subject property is within or near land designated for long-term commercially significant resource use in which natural resource activities are permitted and encouraged, including a variety of activities that may not be compatible with residential or other types of development. These activities may be conducted over periods that extend beyond the normal workday and/or work week and produce noise, dust, smoke, visual impacts, and odors. When performed in accordance with best management practices, these resource utilization activities are to be expected and shall not be subject to legal action or public nuisance.

Final Planning Approval			0.4/0.0/0.0.5	
Review Approved by:	1~ 1~	Date:	04/09/2025	
Review Completed By: Presto	n Pinkston Planner			


Step 2: Site Permitting

Required applications for the proposal described (more applications/information may be required after further review):

Community Development	Public Health and Social Se	rvices Public Works
✓ <u>Address</u>	☐ Well Site Inspection	☐ Road Approach
☐ None, the proposal can submit the	building permitting requiren	nents
Step 3: Development Pern	litting	
Required applications for the proposal d	escribed (more applications/i	information may be required after further review):
Water	Oth	ner
☐ Well Log for Individual Well	J	WCF Application
Water Availability Notification	✓	<u>SEPA</u>
☐ Municipal WAN	✓	Fill and Grade
Two Party/Shared Well	✓	<u>Stormwater</u>
☐ Group B Well	Bui	ilding
Arsenic Testing	✓	Building or Placement Permit
☐ Water Purveyor Consent Form		Building (Change of Use)
Sewage Disposal	✓	Improvements Necessary for Fire Access
☐ Septic Permit		Demolition Permit
Septic Connection/Reconnection		Energy Code Compliance
Sewer Availability		uilding may require engineering depending
	on	plans

WRIA: 26 Cowlitz

*If the well is drilled after January 19, 2018 and you are located in the Chehalis (23), Nisqually (11) or Deschutes Water Basin(13), a \$500 fee and covenant restricting water usage may apply

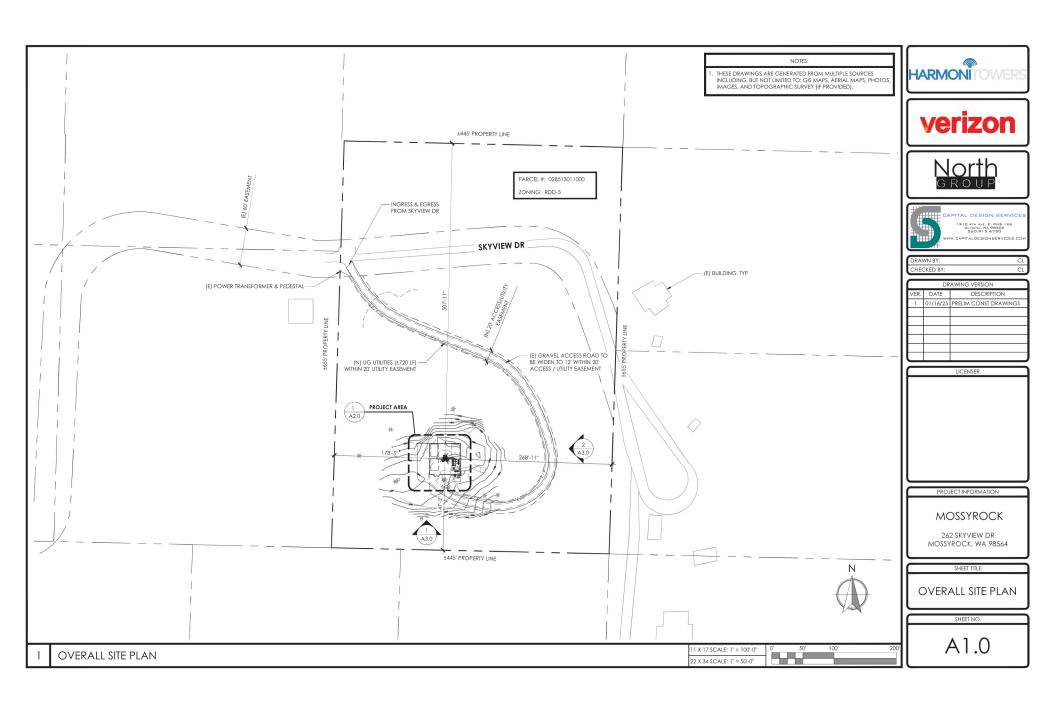

PROJECT SCOPE

PROPOSED INSTALLATION OF A TELECOMMUNICATIONS FACILITY ON AN EXISTING PARCEL.

- 50.0' X 50.0' (2,500 SF) LEASE AREA
- 6.0' TALL CHAIN-LINK FENCE W/ GREEN PRIVACY SLATS & 12.0' WIDE DUAL SWING ACCESS GATE AROUND LEASE AREA
- (4) EQUIPMENT AREAS, (3) FOR FUTURE CARRIERS
- (1) UTILITY H-FRAME W/ (4) METER BASE CAPACITY
- (1) 150.0' MONOPOLE WITHIN FENCED LEASE AREA
- (1) ANTENNA MOUNTING ASSEMBLY, ANTENNAS, RADIOS CARLES & GROUND SITE SUPPORT
- PROPOSED INSTALLATION OF A NEW 800A



MOSSYROCK

262 SKYVIEW DR

MOSSYROCK, WA 98564

HARMONI SITE #: WA0007224 CONSTRUCTION DRAWINGS PROJECT INFORMATION DRIVING DIRECTIONS		GN1.0 GN2.0 E1.0 E1.1	
		DRIVING DIRECTIONS	E2.0
SITE NAME: ADDRESS:	MOSSYROCK 262 SKYVIEW DR MOSSYROCK, WA 98564	FROM VERIZON OFFICE IN PORTLAND, OREGON: 1. HEAD EAST TOWARD 158TH AVE SE	E3.0 E4.0 E5.0
JURISDICTION: PARCEL #: ZONING:	LEWIS COUNTY 028513011000 RDD-5	2. TURN RIGHT ONTO 158TH AVE SE 3. TURN RIGHT ONTO SE EASTGATE WAY 4. TURN LEFT ONTO ITHE 1-PO W RAMP TO SEATTLE CONTROL OF THE SEAT OF THE SEATTLE CONTROL OF THE SEATTLE SEATTLE SEATTLE CONTROL OF THE SEATTLE SEATTLE SEATTLE SEATTLE CONTROL OF THE SEATTLE	
LATITUDE: LONGITUDE: SOURCE:	46° 32' 44.85" N (46.545793°) 122° 30' 16.60" W (-122.504611°)	5. SLIGHT RIGHT ONTO THE 1SOTH AVE SE RAMP 6. TAKE THE RAMP ONTO I-90 7. MERGE ONTO I-90 W	
GROUND ELEVATION:	1061.8'	8. USE THE RIGHT LANE TO MERGE ONTO 1-5 S	I

2.500 SQ FT

VICINITY MAP

TAKE EXIT 68 FOR US 12 E TOWARD MORTON/YAKIMA

LOCALIZED MAP

Harmony Lakeside

TURN LEFT ONTO US-12 F 10

TURN LEFT ONTO BIRLEY RD

12. TURN RIGHT ONTO SKYVIEW DR 13. TURN LEFT TO STAY ON SKYVIEW DR

TOTAL MILES: 120 MILES

SHEET INDEX HARMONITOWER







RAWN BY:	CL
HECKED BY:	CL

	DRAWING VERSION		
VER.	DATE	DESCRIPTION	
1	01/16/25	PRELIM CONST DRAWINGS	

** THE INFORMATION CONTAINED IN THIS SET OF DOCUMENTS IS PROPRIETARY BY NATURE. ANY USE OR DISCLOSURE OTHER THAN THY WHICH RELATES TO THE OWNER IS STRICTLY PROHIBITED.

GOVERNING CODES

2021 INTERNATIONAL MECHANICAL SPECIALITY CODE

2021 INTERNATIONAL FIRE CODE

2021 INTERNATIONAL BUILDING CODE

TITLE SHEET

SURVEY

SURVEY

SURVEY

OVERALL SITE PLAN

FENCE DETAILS

CONSTRUCTION DETAILS

CONSTRUCTION DETAILS

SITE SIGNAGE DETAILS

SITE SIGNAGE DETAILS

ENLARGED UTILITY SITE PLAN

ONE-LINE DIAGRAM & PANEL SCHEDULE

GENERAL NOTES

GENERAL NOTES

UTILITY SITE PLAN

GROUNDING PLAN

GROUNDING DETAILS GENERAL ELECTRICAL NOTES

ENLARGED EXISTING SITE PLAN

ENLARGED PROPOSED SITE PLAN

SV1

SV2

SV3

A1.0

A2.0

A2.1

A3.0

A4.0

A50

A5.1

A6.0

A6.1

2020 NFPA 70 NATIONAL ELECTRICAL CODE (NEC)

2021 WASHINGTON STATE ENERGY CODE

A.D.A. COMPLIANCE INSTALLATION IS UNMANNED / NOT FOR HUMAN HABITATION. HANDICAP ACCESS IS NOT REQUIRED





SHEET TITLE TITLE SHEET

PROJECT INFORMATION

MOSSYROCK

262 SKYVIEW DR MOSSYROCK, WA 98564

SHEET NO.

T1.0


ELECTRICAL SERVICE PROJECT CONTACTS APPLICANT: ATTENTION: HARMONI TOWERS/ PARALLEL INFRASTRUCTURE CHARLOTTE, NC 28277-4864 CHAD RUMSEY PH: 857.756.9022 PROPERTY OWNER: KEVIN RIFFLE PH: 425.445.4000 TOWER OWNER: ATTENTION: HARMONI TOWERS/ PARALLEL INFRASTRUCTURE 6210 ARDREY KELL RD, SUITE 450 CHARLOTTE, NC 28277-4864 CHAD RUMSEY PH: 857.756.9022 SITE ACQUISITION AGENT: NORTH GROUP P.O. BOX 2449 SNOHOMISH, WA 98291 BILL NORTH PH: 425.876.2909 ZONING/PERMITTING AGENT: NORTH GROUP P.O. BOX 2449 SNOHOMISH, WA 98291 RACHEL NORTH PH: 425.280.1376 SURVEYOR: DUNCANSON 145 SW 155TH STREET, SUITE 102 SEATTLE, WA 98166 PH: 206.244.4141 ENGINEER OF RECORD: VECTOR STRUCTURAL ENGINEERING 651 W. GALENA PARK BLVD., SUITE 101 DRAPER, UT 84020

WELLS L. HOLMES, SE PH: 801.990.1775

(N) STRUCTURE HEIGHT:

OCCUPANCY:

(N) GROUND LEASE AREA:

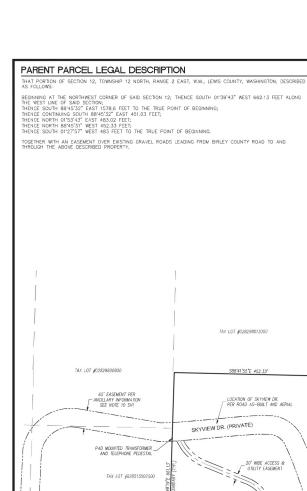

LATITUDE/LONGITUDE

SITE LOCATION

SCALE: 1"=100

P.O.B.

TAY LOT #028513014000

TAX LOT #028298013000

S88'41'55"E 452.33"

LOCATION OF SKYVIEW DR

PER ROAD AS-BUILT AND AERIAL

UTILITY EASEMEN

- SHED

N88"44'08"W 451.03

TAX LOT #028513011000

50'X50' LEASED PREMISES

TITLE EXCEPTIONS:

DUCAMISON COMPANY HAS RECEIVED AND REVIEWED THE TITLE COMMINENT PREPARED BY TITLE UNMARKET COMPANY (CHICAGO TITLE INSURANCE COMPANY) DATED EFFECTIVE MARCH 22, 2024, BEING COMPANY IN 0. 51300, FOR THE SUBJECT PROPERT, TO DETERMINE THE MARCHS OF EXISTING TITLE EXCEPTIONS.

SCHEDULE B. PART II

12. OBLIGATION OF MEMBERSHIP TO LAND OWNER'S ASSOCIATION AS DISCLOSED BY INSTRUMENT RECORDED JUNE 29, 1978 UNDER AUDITOR'S FILE NO. 848411 AND OTHER CONVEYANCE OF RECORD IN THE DEVELOPMENT. BLANKET IN NATURE, AFFECTS ENTIRE PARENT PARCEL, LEASE AREA AND ACCESS AND UTILITY EASEMENT.

13. MMEPAL RESERVATIONS CONTAINED IN DEED SECRETE 31. WILLIAM S. LIDWIG RECORDED : SEPTEMBER 18, 1953 AUDITOR'S NO. : 25.2512. THE COMPANY MAKES NO REPRESENTATION AS TO THE PRESENT OWNERSHIP OF ANY SUCH INTERESTS. THERE MAY BE LEASES, GRANTS, EXCEPTIONS OR RESERVATIONS OF INTERESTS THAT ARE NOT LISTED.

AFFECT ENTIRE PARENT PARCEL LEASE AREA AND ACCESS AND UTILITY EASEMENT.

14. MINERAL RESERVATIONS CONTAINED IN DEED EXECUTED BY: WILLIAM F. BOILEAU AND RUBY OPAL BOILEAU RECORDED: MAY 15, 1961 AUDITOR'S NO. : 625083.

APPROVED

TAX LOT #028299004000

ST TIZN RZE W.M.

\$12 T12W R2E W.M.

TAX LOT #028513019000

TAX LOT #028513020000

TAX LOT #028513017000

FOUND BAR & CAP

- FOUND REBAR (NO CAP)

AUDITUR'S NO. 202063. THE COMPANY MAKES NO REPRESENTATION AS TO THE PRESENT OWNERSHIP OF ANY SUCH INTERESTS THERE MAY BE LEASES, GRANTS, EXCEPTIONS OR RESERVATIONS OF INTERESTS THAT ARE NOT LISTED.

By Preston Pinkston at 1:58 pm, Apr 09, 2025

CERTIFICATION

AFFECTS ENTIRE PARENT PARCEL, LEASE AREA AND ACCESS AND UTILITY EASEMENT.

LOCATION: NAD 83/91 LAT - 46'32'44.85" N LONG - 122'30'16.60" W



- TITLE COMMITMENT ISSUED BY TITLE GUARANTY COMPANY (CHICAGO TITLE INSURANCE COMPANY), ORDER NO. 181300, DATED MARCH 22, 2024.

- COORDINATE SYSTEM, SOUTH ZONE (NAD83/91).

 8) UNDERGROUND UTILITIES SHOWN HEREON, IF ANY
- WERE DELINEATED FROM SURFACE EVIDENCE AND/OR UTILITY COMPANY RECORDS. CRITICAL LOCATIONS SHOULD BE VERTIED PRIOR TO DESIGN AND CONSTRUCTION.

 9) FEMA DESIGNATION: ZONE 'C' (AREAS OF MINIMAL
- FLOODING, (NO SHADING), FIRM MAP NUMBER 5301020500B, EFFECTIVE DATE DECEMBER 15, 1981.
- 1) ALL ELEVATIONS SHOWN ARK ABUNE MEAN SEA LEVEL
 2) ALL TOWER, TREE AND APPURTENANCE HEIGHTS ARE
 ABONE GROUND LEVEL (AGL) AND ARE ACCURATE TO
 ± 0.5 FEET OR ± 1% OF TOTAL HEIGHT, WHICHEVER IS
 GREATER.

LATITUDE/LONGITUDE POSITION

COORDINATE DATA AT CENTER OF PROPOSED MONOPOLE

NAVD 88 ELEV.= 1061.8 FEET



BENCHMARK IS "SWWA" BASED ON WSRN PUGET SOUND REFERENCE NETWORK.

ELEVATION DERIVED USING CPS.
ACCURACY MEETS OR EXCEEDS
1A STANDARDS AS DEFINED ON
THE FAA ASAC INFORMATION

NOTES

- FEE OWNER: KEVIN RIFFLE AND JENNIFER RIFFLE.
- 2) FEE OWNER: KEVIN RIFFLE AND JENNIFER RIFFLE.
 3) DEED REC # 5318567
 4) FIELD WORK CONDUCTED IN SEPTEMBER, 2024.
 5) NO WEILANDS AREAS HAVE BEEN INVESTIGATED BY THIS SURVEY.
 10 LANDSCAPE BUFFERS WERE INVESTIGATED BY THIS SURVEY.
 2) FOR SURVEY BUFFERS WERE INVESTIGATED BY THIS SURVEY.
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- SOJIOZOGOOB, EFFECTIVÉ DATE DECEMBER 15, 1981.

 DEASEMBIT STATEMENT AT END OF LEGAL

 DESCRIPTION GRANT ACCESS TO PARCEL FROM
 BIRLY RODA P PUBLIC RIGHT OF WAY, ALTHOUGH NO
 STATE LEASEMENT WOTH OF 60 FEET WITH RECORDING
 NUMBERS 3207748, 393999, 3205024, AUDION
 AUDION STATE LEASEMENT WOTH OF 60 FEET WITH RECORDING
 NUMBERS 3207748, 393999, 3205024, AUDION
 2025494, THESE RECORDS ARE NOT INCLUDED BY
 RECORDS, AERIAL, AND AS-BUILT INFORMATION.

 11) THE LEASED PREMISES IS CONTIGUOUS ALONG IS
 COMMON BOUNDARIES TO THE ACCESS AND UTILITY
 COMMON BOUNDARIES TO THE ACCESS AND UTILITY
 COMMON BOUNDARIES TO THE PRIVATE ROAD
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 OVERLAPS BETWEEN ARE ANDROG ANY OF SAD
 OVERLAPS BETWEEN AR AMONG ANY OF SAD
 OVERLAPS BETWEEN AR AMONG ANY OF SAD
 OVERLAPS BETWEEN ARE AMONG ANY OF SAD

TREE LEGEND DECIDIOUS TREE

P POWER VAULT

☑ UTILITY BOX

Ø UTILITY POLE

€--- GUY ANCHOR

DI GAS VALVE

GAS METER

NOTE:

T TELEPHONE VAULT

TEL. PEDESTAL

TEL. MANHOLE

M LIGHT STANDARD

LEGEND

AL = ALDER MP=MAPLE DS=DECIDUOUS
TZ TRUNK DIAMETER (IN) MA=MADRONA TYPE CH=CHERRY

ALL ELEVATIONS SHOWN ARE ABOVE MEAN SEA LEVEL

- SUBJECT BOUNDARY LINE

- ADJACENT BOUNDARY LINE

- OVERHEAD POWER LINE

- DITCH LINE/FLOW LINE

BARBED WIRE/WIRE FENCE

-O- FIRE HYDRANT

ER WATER METER

Q FIRE STAND PIPE

■ IRRIGATION CONTROL

☐ CATCH BASIN, TYPE

CATCH BASIN, TYPE

M GATE VALVE

- CHAIN LINK FENCE

- SIGN

BOLLARD

□ MAIL BOX

_234.21 SPOT ELEVATION

CE=CEDAR

DF=DOUGLAS FIR

HE=HEMLOCK PI=PINE

EVG=EVERGREEN

WOOD FENCE

ROCK RETAINING WALL

VEGETATION LINE

OVERHEAD TELEPHONE LINE BURIED TELEPHONE LINE BURIED WATER LINE BURIED SANITARY SEWER BURIED STORM DRAIN

BURIED POWER LINE BURIED GAS LINE

- RIGHT-OF-WAY LINE

- SECTIONAL BREAKDOWN LINE

RIGHT-OF-WAY CENTERLINE

EVERGREEN TREE PL ST=STUMP

- HEIGHT AGL IF MEASURED NOTE: TREE DRIP LINES ARE NOT TO SCALE. TREE SYMBOLS REFERENCE TRUNK LOCATION ONLY. TRUNK DIAMETERS
WERE APPROXIMATED AT 3.5° TO 4° ABOVE GROUND LEVEL.
TREES SHOWN ARE FOR REFERENCE ONLY AND OTHER
TREES AND VEGETATION MAY EXIST.

SITE INFORMATION

028513011000 262 SKYVIEW DR MOSSYROCK, WA 98564 KEVIN RIFFLE 425-445-4000 RDD-5 (LEWS COUNTY) 279± S.F.(??? AC.) 2,500 S.F. SITE CONTACT PHONE NUMBER ZONING TOTAL LOT AREA PROJECT AREA

SURVEY REFERENCE

- RECORD OF SURVEY PER A.F. NO. 3161844, RECORDS OF LEWS COUNTY. QUITCLAIM DEED PER A.F. NO. 3518567, RECORDS OF LEWIS COUNTY.
 - BOUNDARY DISCLAIMER

S PLAN DOES NOT REPRESENT A BOUNDARY RVEY. SUBJECT AND ADJACENT PROPERTY LINES ARE DEPICTED USING FIELD-FOUND EVIDENCE AND RECORD INFORMATION.

UNDERGROUND UTILITIES
EXIST IN THE AREA AND WITHIN THE WORLD THE STATE
ONLY ARCHARD THE STATE
ONE-CALL UTILITY LOCATE
SERVICE AT LEAST 48 HOURS
BEFORE STARTING ANY
CONSTRUCTION.

CONSTRUCTION
CONTROLLOTION.

CONTROLLOTION
CONT









Company, Inc. 145 SW 155th Street, Suite 102 Seattle, Washington 98166 Phone 206,244,4141 1'ax 206,244,4455

MOSSY ROCK 262 SKYVIEW DR. MOSSYROCK, WA 98564

LEWIS COUNTY THE DRAWING WAS CREATED FOR THE EXCLUSIVE USE OF THE CLIENT NAMED HEREON, AND IS NOT TO BE USED IN WHOLE OR IN PART WITHOUT WRITTEN AUTHORIZATION FROM SAID CLIENT. © 2023, DUNGANSON COMPANY, NO.


FLD CREW FLD. BOOK 641/6 DRAWN BY 99544.297 JOB #:

RI	REVISIONS		
DATE	DESCRIPTION	BY	
10/26/24	ADD TITLE INFORMATION	LAC	




SEC 12, TWP 21 N, RNG 2 E, WM

SHEET NUMBER SV1

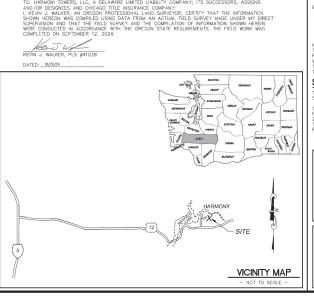

TO: HARMONI TOWERS, LLC, A DELAWARE LIMITED LIABILITY COMPANY; ITS SUCCESSORS, ASSIGNS

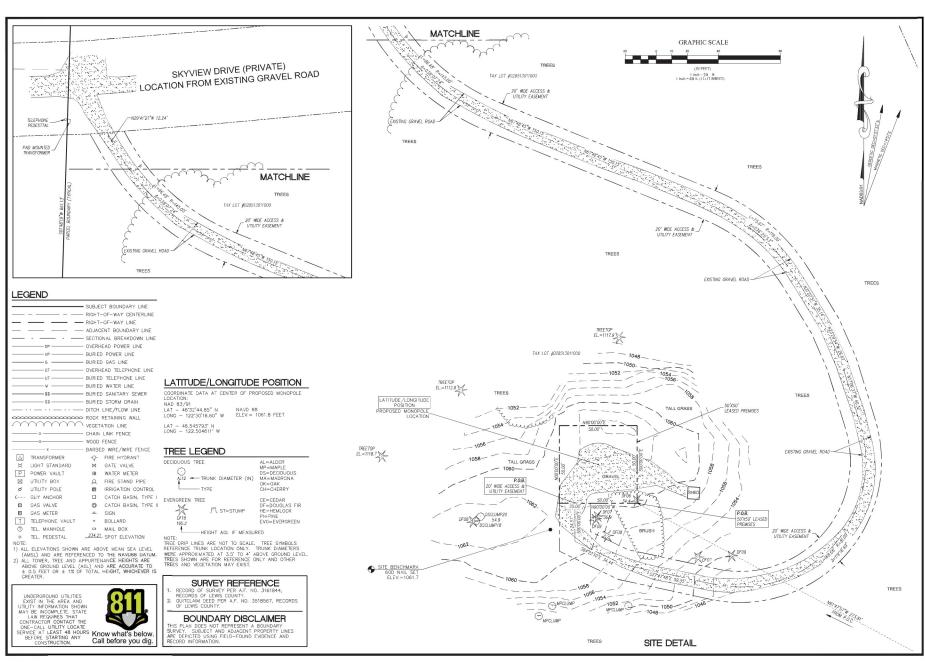







SITE MOSSY ROCK 262 SKYVIEW DR. MOSSYROCK, WA 98564 LEWIS COUNTY


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© 2023, DUNCANS	ON COMPANY, NC.
FLD. CREW:	DC/AH
FLD. BOOK:	641/60
DRAWN BY:	LAC
JOB #:	99544.2970
DATE:	09/16/24

DATE	DESCRIPTION	BY
		╄
		╄
10/26/24	ADD TITLE INFORMATION	LAC



SHEET NUMBER

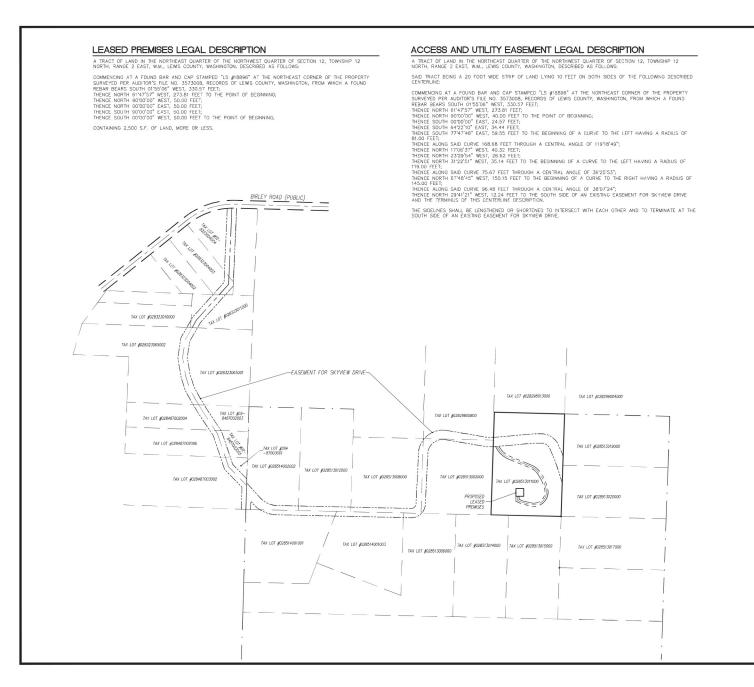

LEGEND - SUBJECT BOUNDARY LINE HARMONI RIGHT-OF-WAY CENTERLINE RIGHT-OF-WAY LINE - ADJACENT BOUNDARY LINE - SECTIONAL BREAKDOWN LINE - OVERHEAD POWER LINE BURIED POWER LINE BURIED GAS LINE - OVERHEAD TELEPHONE LINE BURIED TELEPHONE LINE - BURIED WATER LINE - BURIED SANITARY SEWER BURIED STORM DRAIN - DITCH LINE/FLOW LINE ROCK RETAINING WALL VEGETATION LINE - CHAIN LINK FENCE WOOD FENCE BARBED WIRE/WIRE FENCE -Q- FIRE HYDRANT Y LIGHT STANDARD M GATE VALVE P POWER VAULT ER WATER METER ☑ UTILITY BOX Q FIRE STAND PIPE Ø UTILITY POLE ■ IRRIGATION CONTROL €--- GUY ANCHOR ☐ CATCH BASIN, TYPE DI GAS VALVE CATCH BASIN, TYPE GAS METER - SIGN T TELEPHONE VAULT BOLLARD TEL. MANHOLE □ MAIL BOX D TEL. PEDESTAL _234.21 SPOT ELEVATION ALL ELEVATIONS SHOWN ARE ABOVE MEAN SEA LEVEL 1) ALL ELEVATIONS SHOWN ARE ABUNE MEAN SEA LEVEL. (AMS.) AND ARE REFERENCED TO THE NAVDBB DATUM. 2) ALL TOWER, TREE AND APPURTENANCE HEIGHTS ARE ABONE GROUND LEVEL (AGL) AND ARE ACCURATE TO ± 0.5 FEET OR ± 1% OF TOTAL HEIGHT, WHICHEVER IS GREATER.

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DUNCANSON

Company, Inc.

145 SW 155th Street, Suite 102 Seattle, Washington 98166 Phone 206,244,4141 1'ax 206,244,4455

FLD. CREW:	DC/AH
FLD. BOOK: DRAWN BY:	641/60 LAC
JOB #:	99544.2970
DATE:	09/16/24

l B	REVISIONS		
DATE	DESCRIPTION	BY	
		L	
10/26/2	ADD TITLE INFORMATION	LAC	
		•	





UNDERGROUND UTILITIES
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SERVICE AT LEAST 48 HOURS
BEFORE STARTING ANY
CONSTRUCTION.


CONSTRUCTION
CONSTRUCTION.


CONSTRUCTION
CONSTR SEC 12, TWP 21 N, RNG 2 E, WM

SHEET NUMBER SV3

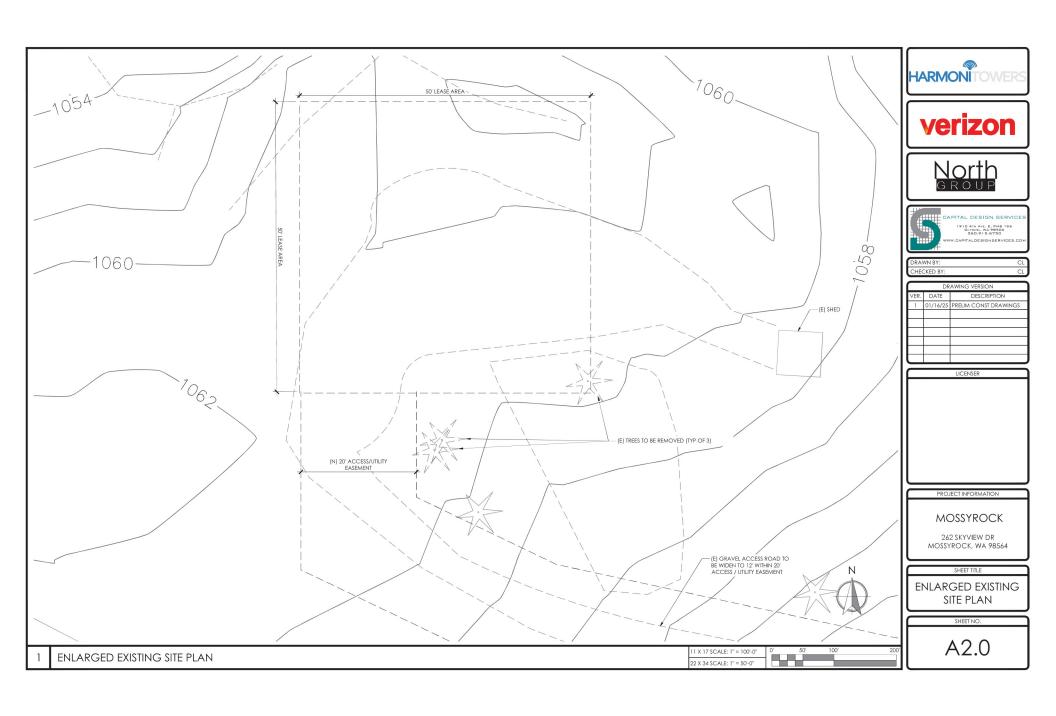


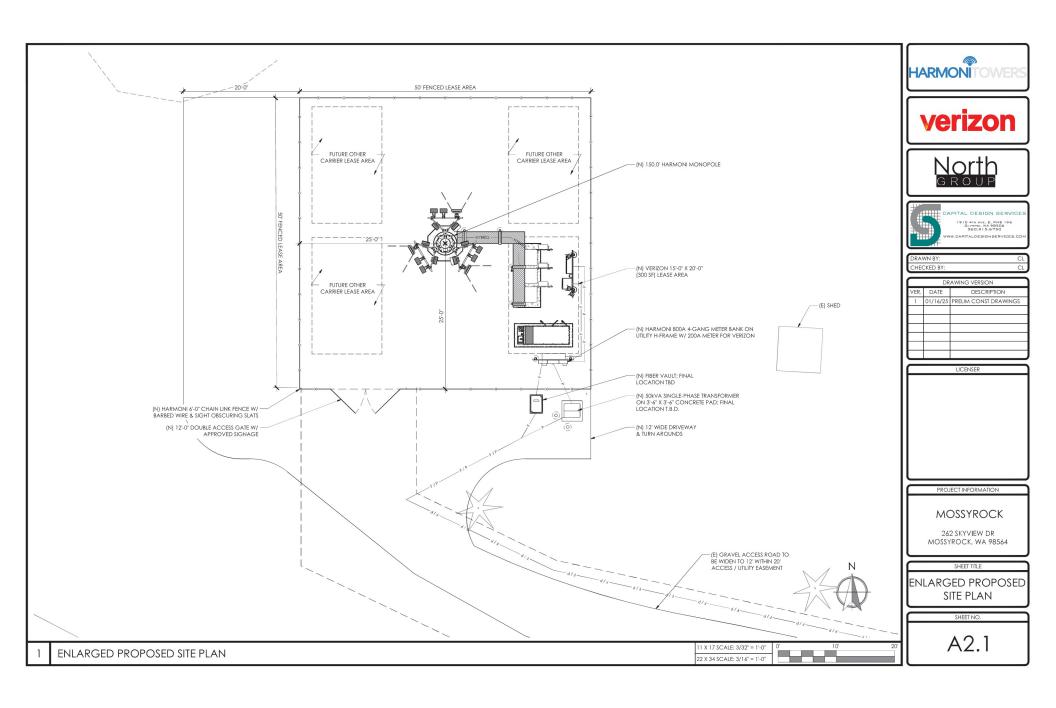

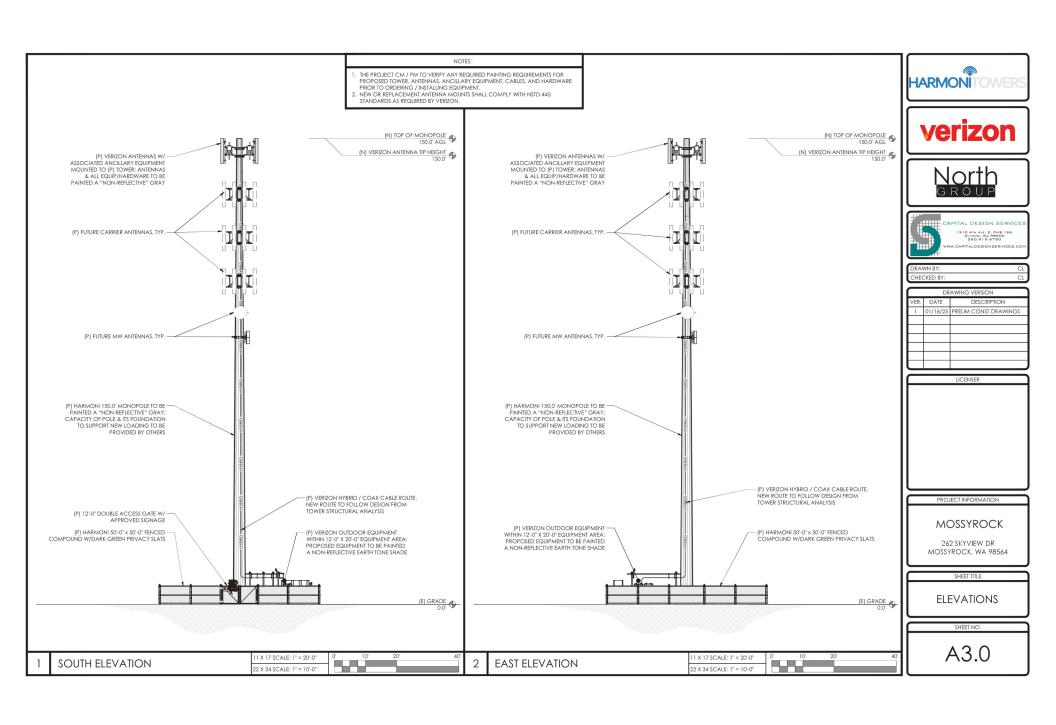

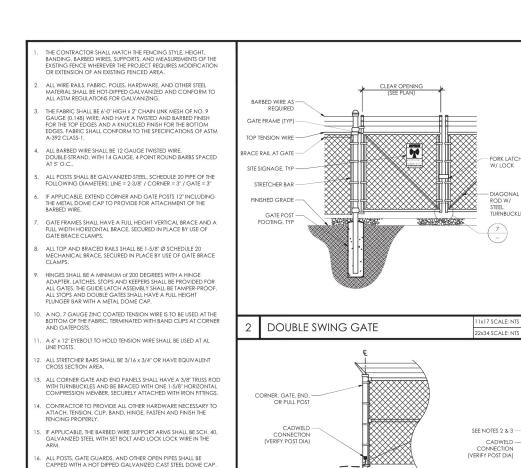


GROUNDING NOTES:

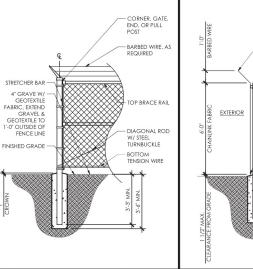

11x17 SCALE: NTS

22x34 SCALE: NTS

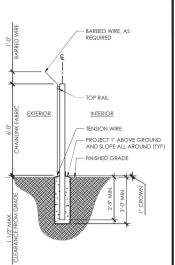









П	DRAWING VERSION			
П	VER.	DATE	DESCRIPTION	
П	1	01/16/25	PRELIM CONST DRAWINGS	
П				
П				
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22x34 SCALE: NTS TOP STRAND OF BARBED WIRE EXTENSION ARM EXTERIOR INTERIOR

WOVEN WIRE

BARBED WIRE

GATE STOP




1x17 SCALE: NTS

1x17 SCALE: NTS

2x34 SCALE: NTS

11x17 SCALE: NTS

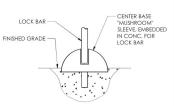


PROJECT INFORMATION MOSSYROCK

262 SKYVIEW DR MOSSYROCK, WA 98564

SHEET TITLE

FENCE DETAILS SHEET NO

A4.0

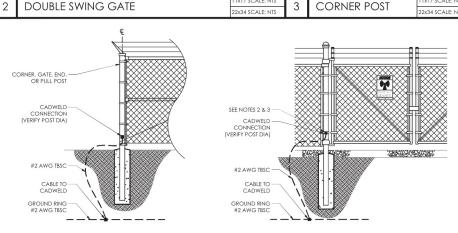

VERTICAL POSTS SHALL BE BONDED TO THE RING AT EACH CORNER AND AT EACH GATE POST, AT MINIMUM, ONE VERTICAL POST SHALL BE

THE GATE JUMPER SHALL BE #4/0 AWG WELDING CABLE OR FLEXIBLE COPPER BRAIDED FLAT STRAP WITH SLEEVES ON EACH END DESIGNED FOR

THE GATE JUMPER SHALL BE INSTALLED SO THAT IT WILL NOT BE SUBJECTED TO DAMAGING STRAIN WHEN GATE IS FULL OPEN IN EITHER DIRECTIONS

BONDED TO THE GROUND RING IN EVERY 100-FOOT STRAIGHT RUN OF FENCE.

FENCE GROUNDING

HE #2 AWG, TBSC, FROM THE RING GROUND SHALL BE CADWELDED TO THE POST, ABOVE GROUND.

FRAME, FABRIC SHALL BE ATTACHED WITH STRETCHER AND TENSION BAND CLIPS AT 1'-3" INTERVALS.

17. ALL POSTS SHALL HAVE A MINIMUM OF 6" OF CONCRETE UNDER THE

LOWER MOST PORTION TO A MINIMUM OF 8" LARGER THAN THE

18. ALL FENCE POSTS SHALL BE SCH. 40 GALVANIZED STEEL POSTS WITH


19. AT CORNER POSTS, GATE POST, LINE POST, AND SIDE OF GATE


DIAMETER AT THE FINISHED GRADE.

NOTES

SET BOLT AND LOCK WIRE IN THE ARM.

- 20. ATTACH FABRIC TO BRACE RAILS, TENSION WIRE AND TRUSS RODS
- WITH THE TIE CLIPS AT 2'-0" INTERVALS. 21. PROVIDE A MAXIMUM GAP OF 1" BETWEEN THE CHAIN LINK FABRIC
- AND THE FINAL GRADE. 22. GATE HINGES SHALL HAVE THEIR THREADS PEENED OR WELDED TO
- PREVENT UNAUTHORIZED REMOVAL, AND GATES SHALL BE INSTALLED SO THAT LOCKS ARE ACCESSIBLE FROM BOTH SIDES.
- 23. CONTRACTOR TO TOUCH UP ALL SCRAPES, SCRATCHES, MARKS, AND BARE AREAS WITH A COLD GALVANIZED SPRAY.

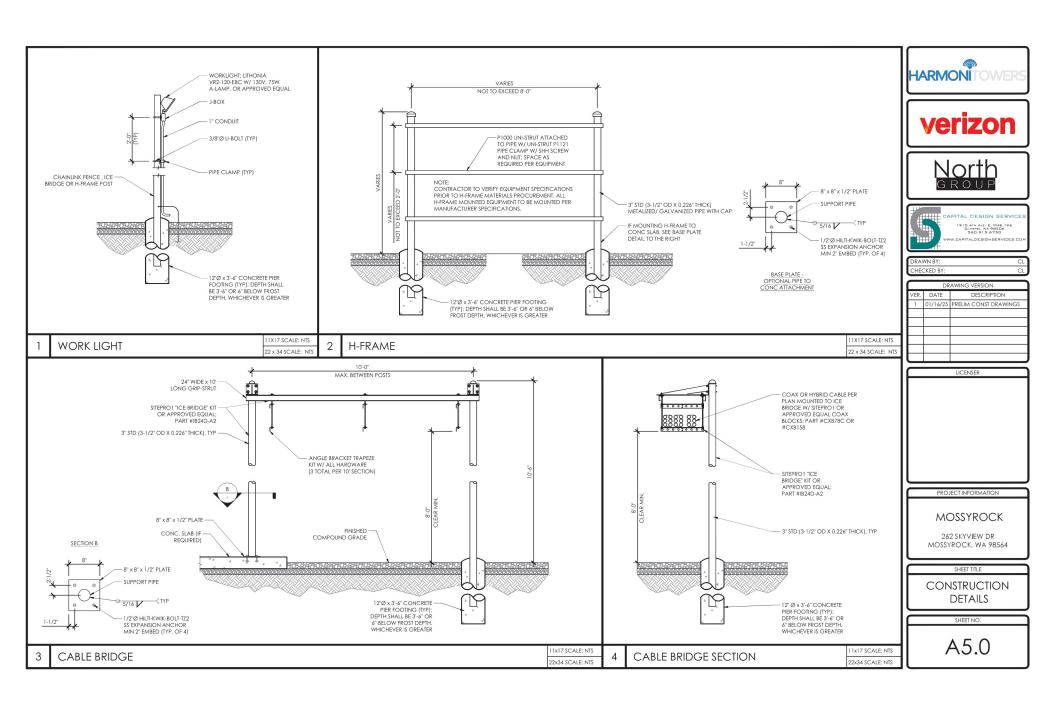

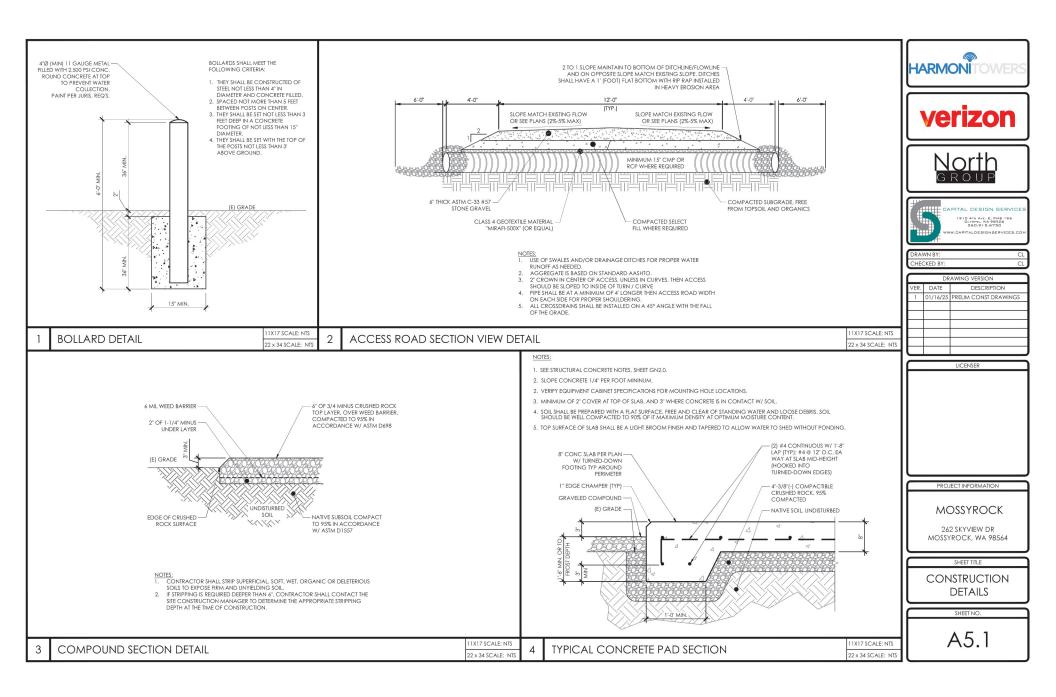

A NOTICE A GUIDELINES FOR WORKING IN RADIOFREQUENCY ENVIRONMENTS

- All personnel should have electromagnetic energy (EME) awareness training.
- All personnel entering this site must be authorized.
- A Obey all posted signs.
- Assume all antennas are active.
- A Before working on antennas, notify owners and disable appropriate transmitters.
- Maintain minimum 3 feet clearance from all antennas.
- A Do not stop in front of antennas.
- ⚠ Use personal RF monitors while working near antennas.
- A Never operate transmitters without shields during normal operation.
- ⚠ Do not operate base station antennas in equipment room.



ASR NUMBER:

SITE NAME: MOSSYROCK

SITE ID: WA0007224

FOR LEASING INFORMATION CALL: 501.850.0820

IN CASE OF EMERGENCY CALL: 844.398.9716

HARMONITOWER







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DRAWING VERSION		
VER. DATE DESCRIPTION		DESCRIPTION
1	01/16/25	PRELIM CONST DRAWINGS

11X17 SCALE: NTS RFE GUIDELINE SIGNAGE HARMONI SITE ID SIGNAGE 22 x 34 SCALE: NT 22 x 34 SCALE: NTS MOSSYROCK **DETAILS**

PROJECT INFORMATION

262 SKYVIEW DR MOSSYROCK, WA 98564

SITE SIGNAGE

A6.0

11X17 SCALE: NTS

22 x 34 SCALE: NT

1X17 SCALE: NTS **NOT USED** 22 x 34 SCALE: NTS

NOT USED

1X17 SCALE: NTS 22 x 34 SCALE: NTS

NOT USED



- 1. LOW LEVEL (BLUE) WARNING SIGNS (PLACE AT SITE ENTRY/ACCESS POINTS
 - ROOF TOPS: PLACE SIGNS ON THE INSIDE OF ROOF HATCH, PLACE ON ACCESS DOOR UNLESS DOOR IS USED BY GENERAL PUBLIC OR BUILDING TENANTS REGULARLY FOR ACCESS. IN THESE CASES, CONSULT CONSTRUCTION MANAGER OR QC SUPERVISOR.

 • WATER TANKS: PLACE SIGNS ON COMPOUND GATE.

 - VERIZON -OWNED SITES: PLACE ONE SIGN ON SITE GATE.
- 2. HIGH LEVEL (RED) CAUTION SIGNS (PLACE AT ALL ANTENNA SECTORS WHERE
 - . ALL SIGNS WILL BE SECURED WITH EITHER STAINLESS STEEL ZIP TIES OR STAINLESS TECH SCREWS.

3. CC PARTICIPATION IN SIGN LOCATION:

- CM WILL MEET WITH ALL CC'S TO OUTLINE CRITERIA FOR SIGN PLACEMENT, EMPHASIS WILL BE ON 'GRAY AREA' SITES. WHERE SIGN PLACEMENT IS PARTICULARLY CHALLENGING, WE WILL GIVE CC'S AS MUCH GUIDANCE ON SPECIFIC SITUATIONS AS WE CAN FORESEE, BUT CC'S WILL BE ENCOURAGED TO PARTNER WITH CM OR OC IN DECIDING PLACEMENT OF DIFFICULT SITES. A JOINT SITE VISIT MAY BE REQUIRED TO FULFILL REQUIREMENTS.
- . CC WILL CALL OUT SIGN LOCATION(S) AT THE A&E WALK FOR EACH SITE AS THOSE OCCUR
- ON SITES WITH EXISTING A&E BUT NOT YET CONSTRUCTED, CC WILL BE ASKED TO PROVIDE (WITHIN A REASONABLE TIME FRAME TBD) A DETAIL FOR SIGN PLACEMENT THAT WILL BE SLIP-SHEETED INTO EXISTING SETS.


4. SIGN DISBURSEMENT FROM WAREHOUSE:

NOTES

 SIGNS WILL BE IN STOCK AT KENT WAREHOUSE TO BE DISRUPSED AS PART. OF THE GC BOM AS CALLED OUT IN A&E DRAWINGS FOR EACH SITE.



- 1. FOR VERIZON LOGO SEE VERIZON DESIGN SPECIFICATIONS (PROVIDED BY VERIZON)
- 2. ALL TEXT FONT IS ARIAL U.N.O. CONTRACTOR TO PROCURE FCC NO. FROM COMPLIANCE COORDINATOR PH: (425) 895-7000
- TEXT FOR SIGNAGE SHALL INDICATE CORRECT SITE NAME AND NUMBER AS PER VERIZON. CONSTRUCTION MANAGER RECOMMENDATIONS.
 CABINET / SHELTER MOUNTING APPLICATION REQUIRES ANOTHER PLATE APPLIED TO THE FACE OF THE CABINET WITH WATER PROOF.
- POLYURETHANE ADHESIVE.

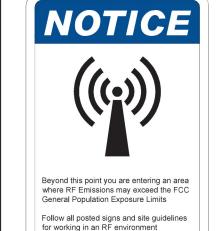









П		DRAWING VERSION		
Ш	VER.	DATE	DESCRIPTION	
Ш	1	01/16/25	PRELIM CONST DRAWINGS	
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ACAUTION



Radio frequency fields near some antennas may exceed FCC rules for human exposure.

Personnel climbing this tower should be trained for working in radio frequency environments and use a personal RF monitor if working near active antennas.

Ref: FCC 47cfr 1.137(b)

INFORMATION

VERIZON SITE SIGNAGE

VERIZON operates telecommunications antennas at this location Remain at least 3 feet away from any antenna and obey all posted signs

Contact the owner(s) of the antenna(s) before working closer then 3 feet from the antenna(s)

Contact VERIZON at (VERIFY PHONE#) prior to performing any maintenance or repairs near VERIZON antennas

This is site# Contact the management office if this door/hatch/gate is

INFORMACION

En esta propiedad se ubican antenas de telecommunicaciones operaadas par VERIZON Favor mantener una disiancia de no menos de 3 pies y obedecar todos las avisos

Comuniquese can el propietaria o las propiatarios de las antes de trabajar o caminar de menos de 3 pies de la antena

Comuniquese can VERIZON (PHONE#) antes de realizar cualquier antenimiento a reparaciones cera de las antenas de VERIZON

Esta es la estacion base numero

favor comunicarse can la oficina de la administracion del adificio si esta puerta o compuerta se encuentra sin canado

NFPA 704 HAZARD **IDENTIFICATION SYSTEM** 15" DIAMOND

WASHER OTHER SIDE, (4) PLACES

1x17 SCALE: NTS

2x34 SCALE: NTS



HAZARD RATINGS:

NINE O'CLOCK: TWELVE O'CLOCK: THREE O'CLOCK: SIX O'CLOCK:

FLAMMABILITY INSTABILITY SPECIAL

REFERENCES:

NFPA 704 UFC 7901.9 IFC 2703.5



Ref: FCC 47cfr 1.137(b)

RF WARNING SIGN

TRESPASSING

PROJECT INFORMATION

MOSSYROCK

262 SKYVIEW DR MOSSYROCK, WA 98564

SITE SIGNAGE **DETAILS**

SHEET NO.

A6.1

RF WARNING SIGN

FUEL STORAGE SIGN

2x34 SCALE: NTS

2x34 SCALE: NTS

INFORMATION SIGN

6 2x34 SCALE: NTS

1x17 SCALE: NTS

NO TRESPASSING SIGN

1x17 SCALE: NTS

11x17 SCALE: NTS

GENERAL CONSTRUCTION NOTES

- ALL WORK SHALL ADHERETO THE REQUIREMENTS OF THE LOCAL BUILDING CODE (LATEST EDITION), AND ALL
 OTHER APPLICABLE CODES AND ORDINANCES AS REQUIRED BY THE JURISDICTION.
- CONTRACTOR SHALL CONSTRUCT SITE IN ACCORDANCE WITH THESE DRAWINGS AND THE CARRIER
 INTEGRATED CONSTRUCTION STANDARDS FOR WIRELESS SITES (LATEST REVISION), SPECIFICATIONS ARE THE
 RULING DOCUMENTS, AND ANY DISCREPANCIES BRUEEN THE SPECIFICATIONS AND THESE DRAWINGS
 SHOULD BE BROUGHT TO THE ATTENTION OF THE ENGINEER OF RECORD (EOR) PRIOR TO PROCEEDING WITH
 CONSTRUCTION
- THE DRAWINGS ARE NOT TO BE SCALED. THESE PLANS ARE INTENDED TO BE A DIAGRAMMATIC OUTLINE ONLY, UNLESS OTHERWISE NOTED. THE WORKS SHALL INCLUDE FURNISHING MATERIALS, EQUIPMENT AND APPURTENANCES, AND LABOR NECESSARY TO EFFECT ALL INSTALLATIONS AS INDICATED ON THE PRAYINGS.
- 4. CONTRACTOR SHALL VISIT THE JOB SITE AND SHALL FAMILIARIZE HIMSEE WITH ALL CONDITIONS AFFECTING THE PROPOSED WORK AND SHALL MAKE PROVISIONS AS TO THE COST THEREOF, FIELD CONDITIONS INCLUDING DIMENSIONS, AND CONFIRMING THAT THE WORK MAY BE ACCOMPLISHED AS SHOWN IN THE DRAWNIGS FRICK TO PROCEEDING WITH CONSTRUCTION, IS REQUIRED. ANY DISCREPANCIES SHALL BE BROUGHT TO THE ATTENTION OF THE EOP PRIOR TO THE COMMENCEMENT OF WORK, NO COMPENSATION WILL BE AWARDED BASED ON CLAIM OF LACK OF NOWLEDGE OF FIELD CONDITIONS.
- DIMENSIONS SHOWN ARE TO PRISHS SUPPRACES UNLESS OTHERWISE NOTED, SPACING BETWEEN EQUIPMENT IS REQUIRED CLEARANCE, THEREFORE, IT IS CRITICAL TO FILE D'VERFY DIMENSIONS, AND SHOULD THERE BE ANY QUESTIONS RECARDING THE CONTRACT DOCUMENTS, EXISTING CONDITIONS AND/OR DESIGN INTENT, THE CONTRACTOR SHALL BE RESPONSIBLE FOR OBSTAINING THE WORK.
- DETAILS ARE INTENDED TO SHOW DESIGN INTENT. MODIFICATIONS MAY BE REQUIRED TO SUIT JOB
 DIMENSIONS OR CONDITIONS, AND SUCH MODIFICATIONS SHALL BE INCLUDED AS PART OF THE WORK.
- CONTRACTOR SHALL RECEIVE CLARIFICATION IN WRITING, AND SHALL RECEIVE IN WRITING AUTHORIZATION
 TO PROCEED BEFORE STARTING WORK ON ANY ITEMS NOT CLEARLY DEFINED OR IDENTIFIED BY THE
 CONTRACT DOCUMENTS.
- CONTRACTOR SHALL SUPERVISE AND DIRECT THE WORK USING THE BEST CONSTRUCTION SKILLS AND ATTENTION. CONTRACTOR SHALL BE SOLD KESPONSIBLE FOR CONSTRUCTION MEANS, MEHADDS, TECHNIQUES, SEQUENCES AND PROCEDURES AND OR COORDINATING ALL PORTIONS OF THE WORK UNDER CONTRACT, JUNESS OTHERWISE NOTED.
- CONTRACTOR SHALL BE RESPONSIBLE FOR THE SAFETY OF THE WORK AREA, ADJACENT AREAS AND BUILDING OCCUPANTS THAT ARE LIKELY TO BE AFFECTED BY THE WORK UNDER THIS CONTRACT, WORK SHALL CONFORM TO ALL OSHA REQUIREMENTS.
- CONTRACTOR SHALL COORDINATE HIS WORK WITH THE SUPERINTENDENT OF BUILDINGS & GROUNDS AND SCHEDULE HIS ACTIVITIES AND WORKING HOURS IN ACCORDANCE WITH THE REQUIREMENTS.
- 11. CONTRACTOR SHALL BE RESPONSIBLE FOR COORDINATING HIS WORK WITH THE WORK OF OTHERS AS IT MAY RELATE TO RADIO EQUIPMENT, ANTENNAS AND ANY OTHER PORTIONS OF THE WORK.
- 12. INSTALL ALL EQUIPMENT AND MATERIALS IN ACCORDANCE WITH MANUFACTURERS RECOMMENDATIONS UNLESS SPECIFICALLY OTHERWISE INDICATED OR WHERE LOCAL CODES OR REGULATIONS TAKE PRECEDENCE.
- MAKE NECESSARY PROVISIONS TO PROTECT EXISTING SURFACES, EQUIPMENT, IMPROVEMENTS, PIPING ETC. AND IMMEDIATELY REPAIR ANY DAMAGE THAT OCCURS DURING CONSTRUCTION.
- 14. IN DRILLING HOLES INTO CONCRETE WHETHER FOR FASTENING OR ANCHORING PURPOSES, OR PENETRATIONS THROUGH THE FLOOR FOR CONDUIT RUNS, PIPE RUNS, ETC., MUST BE CLEARLY UNDERSTOOD THAT REINFORCING STEEL SHALL NOT BE DRILLED INTO, CUT OR DAMAGED UNDER ANY CIRCUMSTANCES (UNLESS NOTED OTHERWISE), LOCATIONS OF REINFORCING STEEL ARE NOT DEFINITELY KNOWN AND THEREFORE MUST BE SEARCHED FOR BY A PROPRIATE METHODS AND EQUIPMENT.
- 15. REPAIR ALL EXISTING WALL SURFACES DAMAGED DURING CONSTRUCTION SUCH THAT THEY MATCH AND BURNING WITH AD IACENT SURFACES
- 16. SEAL PENETRATIONS THROUGH FIRE RATED AREAS WITH U.L. LISTED AND FIRE CODE APPROVED MATERIALS.
- 17. KEEP CONTRACT AREA CLEAN, HAZARD FREE, AND DISPOSE OF ALL DIRT, DEBRIS, AND RUBBISH, EQUIPMENT NOT SPECIFIED AS REMAINING ON THE PROPERTY OF THE OWNER SHALL BE REMOVED, LEAVE PREMISES IN CLEAN CONDITION AND FREE FROM PAINT SPOTS, DUST, OR SMUDGES OF ANY NATURE. CONTRACTOR SHALL BE RESPONSIBLE FOR MAINTAINING ALL HEMS UNTIL COMPLETION OF CONSTRUCTION.
- 18. MINIMUM BEND RADIUS OF ANTENNA CABLES SHALL BE IN ACCORDANCE WITH CABLE MANUFACTURERS
- 19. ALL EXISTING PIACTUS SEWER, WATER, GAS, ELECTRIC, AND OTHER UTILITIES, WHICH INTEFFERE WITH THE EXECUTION OF THE WORK; SHALL BE FEMOVED AND/OR CAPPED, PLUGGED OF OTHERWISE DISCONTINUED AT POINTS WHICH WILL NOT INTEFFERE WITH THE EXECUTION OF THE WORK, SUBJECT TO THE APPROVAL OF THE BYGINEER.
- CONTRACTOR SHALL MINIMIZE DISTURBANCE TO EXISTING SITE DURING CONSTRUCTION, EROSION CONTROL
 MEASURES, I FREQUIED DURING CONSTRUCTION SHALL BE IN CONFORMANCE WITH JURISDICTIONAL OR
 STATE AND LOCAL GUIDELINES FOR EROSION AND SEDIMENT CONTROL AND COORDINATED WITH LOCAL
 PREQUILATORY AUTHORITIES.
- 2.1. LIGHT SHADED LINES AND NOTES REPRESENT WORK PREVIOUSLY DONE, DARK SHADED LINES AND NOTES REPRESENT THE SCOPE OF WORK FOR THIS POLICET, CONTRACTOR SHALL USENTY FEXTING CONSTRUCTION IS COMPLETE, CONTRACTOR SHALL NOTIFY BUGINERY OF ANY EXISTING CONDITIONS THAT DEVIALE ROOM THE DRAWINGS PRIOR TO BEGINNING CONSTRUCTION.
- CONTRACTOR SHALL SEQUE ALL NICESSARY PERMITS AND/OR WIRING CERTIFICATES REQUIRED FOR THE ELECTRICAL SERVICE UPGRADE. IN ADDITION, CONTRACTOR SHALL PROVIDE ALL NECESSARY COORDINATION AND SCHEDULING WITH THE SERVING ELECTRICAL UTILITY AND LOCAL INSPECTION
- 23. CONTRACTOR TO VERIFY ALL ASPECTS OF THE EXISTING STRUCTURE FOR CONFORMITY WITH THE VALUES SHOWN IN THESE DRAWINGS AND NOTIFY THE E.O.R. IF ANY DISCREPANCIES ARE FOUND. ALL ELEMENTS OF EXISTING STRUCTURE TO REMAIN UND

SITE WORK NOTES

- 1. DO NOT EXCAVATE OR DISTURB BEYOND THE PROPERTY LINES OR LEASE LINES, UNLESS OTHERWISE NOTED.
- 2. DO NOT SCALE BUILDING DIMENSIONS FROM DRAWING
- 3. SIZE, LOCATION AND TYPE OF ANY UNDERGROUND UTILITIES OR IMPROVEMENTS SHALL BE ACCURATELY NOTED AND PLACED ON AS-BUILT DRAWINGS BY GENERAL CONTRACTOR AND ISSUED TO ARCHITECT/PROINERS AT COMPLETION OF PROJECT.
- 4. ALL EXISTING UTILITIES, FACILITIES, CONDITIONS AND THEIR DIMENSIONS SHOWN ON PLANS HAVE BEEN PLOTTED FROM A VAILABLE RECORDS. THE ENGINEER AND OWNER ASSUME NOT RESPONSIBILITY WHATSCEVER AT 0.T HE SUFFICIENCY OR ACCURACY OF THE INFORMATION SHOWN ON THE PLANS OR THE MANNER OF THEIR REMOVAL OR ADJUSTMENT. CONTRACTOR SHALL BE RESPONSIBLE FOR DETERMINING EXACT LOCATION OF ALL EXISTING UTILITIES AND FACILITY OF CONSTRUCTION CONTRACTOR SHALL ALSO OBTAIN FROM EACH UTILITY COMPANY DETAILED INFORMATION RELATIVE TO WORKING SCHEDULES AND METHODS OF REMOVING OR ADJUSTING EXISTING UTILITIES.
- 5. CONTRACTOR SHALL YERRY ALL BUSING UITLIES BOTH HORBONTALLY AND VERTICALLY PRIOR TO START OF CONSTRUCTION. ANY DISCREPANCES OF DOUBLES AS TO THE INTERPRETATION OF PLANS SHALL BE IMMEDIATELY REPORTED TO THE ARCHITECT/ENCINEER FOR RESOLUTION AND INSTRUCTION. AND IN PURITIES WORK SHALL BE FERFORMED UITLINED RECEPTORY IS CHECKED AND CORRECTED BY THE ARCHITECT/ENGINEER. FAILURE TO SECURE SUCH INSTRUCTION MEANS CONTRACTOR WILL HAVE WORKED AT HIS/HER OWN RISK AND EXPENSE.
- CONTRACTOR SHALL CALL LOCAL DIGGER HOT LINE FOR UTILITY LOCATIONS 48 HOURS PRIOR TO START OF CONSTRUCTION.
- ALL NEW AND EXISTING UTILITY STRUCTURES ON SITE AND IN AREAS TO BE DISTURBED BY CONSTRUCTION SHALL BE ADJUSTED TO FINISH ELEVATIONS PRIOR TO FINAL INSPECTION OF WORK.
- 8. GRADING OF THE SITE WORK AREA IS TO BE SMOOTH AND CONTINUOUS IN SLOPE AND IS TO FEATHER INTO EXISTING GRADES AT THE GRADING LIMITS.
- ALL TEMPORARY EXCAVATIONS FOR THE INSTALLATION OF FOUNDATIONS, UTILITIES, ETC., SHALL BE PROPERLY LAID BACK OR BRACED IN ACCORDANCE WITH CORRECT OCCUPATIONAL SAFETY AND HEALTH ADMINISTRATION (OSHA) REQUIREMENTS.
- 10. STRUCTURAL FILLS SUPPORTING PAVEMENTS SHALL BE COMPACTED TO 95% OF MAXIMUM STANDARD PROCTOR DRY DENSITY.
- NEW GRADES NOT IN BUILDING AND DRIVEWAY IMPROVEMENT AREA TO BE ACHIEVED BY FILLING WITH APPROVED CLEAN FILL AND COMPACTED TO 95% OF STANDARD PROCTOR DENSITY.
- 12. ALL FILL SHALL BE PLACED IN UNIFORM LIFTS. THE UFTS THICKNESS SHOULD NOT EXCEED THAT WHICH CAN BE PROPERLY COMPACTED THROUGHOUT ITS ENTIRE DEPTH WITH THE EQUIPMENT AVAILABLE.
- 13. ANY FILLS PLACED ON EXISTING SLOPES THAT ARE STEEPER THAN 10 HORIZONTAL TO 1 VERTICAL SHALL BE PROPERLY BENCHED INTO THE EXISTING SLOPE AS DIRECTED BY A GEOTECHNICAL ENGINEER.
- 14. CONTRACTOR SHALL CLEAN ENTIRE SITE DAILY AFFER CONSTRUCTION SUCH THAT NO PAPERS, THRASH, WEEDS, BRUSH OR ANY OTHER DEPOSITS WILL REMAIN. ALL MATERIALS COLLECTED DURING CLEANING OPERATIONS SHALL BE DISPOSED OF OFFSITE BY THE GENERAL CONTRACTOR.
- ALL TREES AND SHRUBS WHICH ARE NOT IN DIRECT CONFLICT WITH THE IMPROVEMENTS SHALL BE PROTECTED BY THE GENERAL CONTRACTOR.
- 16. ALL SITE WORK SHALL BE CAREFULLY COORDINATED BY GENERAL CONTRACTOR WITH LOCAL UTILITY COMPANY, TELEPHONE COMPANY, AND ANY OTHER UTILITY COMPANIES HAVING JURISDICTION OVER THIS LOCATION.

FOUNDATION, EXCAVATION AND BACKFILL NOTES

- 1. ALL FINAL GRADED SLOPES SHALL BE A MAXIMUM OF 3 HORIZONTAL TO 1 VERTICAL.
- 2. ALL EXCAVATIONS PEEPARED FOR PLACEMENT OF CONCRETE SHALL BE OF UNDSTURBED SOILS, SUBSTANTIALLY HORDONAL AND FREE FROM ANY LOOSE UNSUITABLE MATERIAL OF PROZEES SIGN. AND WITHOUT THE PRESENCE OF POUNDING WATER. DEWATERING FOR EXCESS GROUND WATER SHALL BE PROVIDED WHEN REQUIRED, COMPACTION OF SOILS UNDER CONCRETE PAD FOUNDATIONS SHALL NOT BE LESS THAN 95% OF THE MODIFIED PROCTOR MAXIMUM DRY DENSITY FOR THE SOIL IN ACCORDANCE WITH ASTIM DISST.
- 3. CONCREE FOUNDATIONS SHALL NOT BE PLACED ON ORGANIC OR UNSUITABLE MATERIAL. IF INADEQUATE BEARING CAPACITY IS REACHED AT THE DESIGNED EXCAVATION DEPTH, LIFE UNSAITS ACTIONS YOLI SHALL BE EXCAVATED IN 18 THE LIBERTH AND EITHER BE REPLACED WITH MECHANICALLY COMPACIED GRANULAR MATERIAL OR THE EXCAVATION SHALL BE FILLED WITH CONCRETE OF THE SAMP HEYE SPECIFIED FOR THE FOUNDATION. CRUSHED STONE MAY BE USED TO STABILLED HER DOTTOM OF THE EXCAVATION, ANY STONE SUB BASE MATERIAL, IF USED, SHALL NOT SUBSTITUTE FOR REQUIRED HICKNESS OF CONCRETE.
- 4. ALL EXCAVATIONS SHALL BE CLEAN OF UNSUITABLE MATERIAL SUCH AS VEGETATION, TRASH, DEBRIS, AND SO FORTH PRIOR TO BACK FILLING, BACK FILL SHALL CONSIST OF APPROVED MATERIALS SUCH AS EARTH, LOAM SANDY CLAY, SAND AND GRAVEL, OR SOFT SHALE, FREE FROM CLODS OR LARGE STONES OVER 2 1/2" MAX DIMENSIONS, ALL BACK FILL SHALL BE PLACED IN COMPACTED LAYERS.
- ALL FILL MATERIALS AND FOUNDATION BACK FILL SHALL BE PLACED MAXIMUM 6" THICK LIFTS BEFORE
 COMPACTION, EACH LIFT SHALL BE WETTED IT BERQUIRED AND COMPACTED TO NOT LESS THAN 95% OF
 THE MODIFIED PROCTOR MAXIMUM DRY DENSITY FOR SOLIL IN ACCORDANCE WITH ASTM D1557.
- 6. NEWLY PLACED CONCRETE FOUNDATIONS SHALL CURE A MINIMUM OF 72 HRS PRIOR TO BACK FILLING.
- 7. FINISHED GRADING SHALL BE SLOPED TO PROVIDE POSITIVE DRAINAGE AND PREVENT STANDING WATER. THE RINAL (FINISH) ELEVATION OF SLAB FOUNDATIONS SHALL SLOPE AWAY IN ALL DIRECTIONS FROM THE CONTER. PINISH GRADE OF CONCRETE PADS SHALL BE A MAXIMUM OF 4 INCHES ABOVE FINIAL FINISH GRADE ELEVATIONS. PROVIDE SURFACE FILL GRAVEL TO ESTABLISH SPECIFIED ELEVATIONS WHEEP EPPLY INFO.
- 8. NEWLY GRADED SURFACE AREAS TO RECEIVE GRAVEL SHALL BE COVERED WITH GEOTEXTILE FABRIC TYPE: TYPAR-SA01 AS MANUFACTURED BY "CONSTRUCTION MATERIAL 1-800-229-3841" OR AN APPROVED EQUIVALENT, SHOWN ON PLANS, HE GEOTEXTHE FABRIC SHALL BE BLACK IN COLOR TO CONTROL THE RECURRENCE OF VESTEATINE GROWIN AND EVENT IO WITHIN 1 POOT OUTSIDE THE STEP FEMENT OR ELECTRICAL RECOUNDING SYSTEM PREMIETER WHICH EVER SORGATER, ALL FABRIC SHALL BE COVERED WITH A MINIMUM OF 4 DEEP COMPACTED STORM OR GRAVEL AS STREIGHED, I.E. PDOT TYPE NO. 57 FOR FRANCES COMPOUND, THOT IN THE NO. 57 FOR ACCESS DRIVE AREA.

- IN ALL AREAS TO PECEIVE FILL REMOVE ALL VEGETATION, TOPSOIL DEBRIS, WET AND UNSATISFACTORY SOLI MATERIALS, DISTRUCTIONS, AND DELETERIOUS MATERIALS FROM GROUND SURFACE, PLOW STRIP OR BREAK UP SLOPED SURFACES STEEPER THAN 1 VERTICAL TO 4 HORIZONIAL SUCH THAT FILL MATERIAL WILL BIND WITH EASTING/PREPARED SOIL SURFACE.
- 10. WHEN SUB GRADE OR PREPARED GROUND SURFACE HAS A DENSITY LESS THAN THAT REQUIRED FOR THE FILL MATERIAL, SCAPIET THE GROUND SURFACE TO DETH REQUIRED. PULYDETICE, MOISTURE-CONDITION AND/OR A GRATETHE SOILS AND RE-COMPACT TO THE REQUIRED DENSITY PRIOR TO PLA CEMENT OF FILLS.
- 11. IN AREAS WHICH EXISTING GRAVEL SURFACING IS REMOVED OR DISTURBED DURING CONSTRUCTION OPERATIONS, REPLACE GRAVEL SURFACING TO MATCH ADJACENT GRAVEL SURFACING AND RESTORED TO THE SAME THICKNESS AND COMPACTION AS SPECIFIED, ALL RESTORED GRAVEL SURFACING SHALL BE FREE FROM CORRUGATIONS AND WAVES.
- MISTING GRAVE, SURFACING HAY SE EXCAVATED SEPARATELY AND REUSED WITH THE
 CONDITION THAT ANY UNA-VORABLE AMOUNTS OF ORGANIC MATTER, OF OTHER DELETRIOUS
 MATERIALS ARE REMOYED PRIOR TO REUSE, FURNISH ANY ADDITIONAL GRAVEL RESURFACING
 MATERIAL AS NEEDED TO PROVIDE A FULL DEPTH COMPACTED SURFACE THROUGHOUT SITE.
- 13. GRAVEL SUB SURFACE SHALL BE PREPARED TO REQUIRED COMPACTION AND SUB GRADE ELEVATIONS BEFORE GRAVEL SHACKING IS FLACED AND/OR RESTORED. ANN LOOSE OR DISTURBED MATERIALS SHALL BE HI-OROUGHLY COMPACTED AND ANY DEPRESSIONS IN 1 HE SUB GRADE SHALL BE FILLED AND COMPACTED WITH A PPROVED SELECTED MATERIAL, GRAVEL SURFACIOR MATERIAL SHALL NOT BE SUED FOR FILLING DEPRESSIONS IN THE SUB GRADE.
- 14. PROTECT EXISTING GRAVEL SURFACING AND SUB GRADE IN AREAS WHERE EQUIPMENT LOADS
- 15. DAMAGE TO EXISTING STRUCTURES AND/OR UTILITIES RESULTING FROM CONTRACTORS NEGLIGENCE SHALL BE REPAIRED AND/OR REPLACED TO THE OWNERS SATISFACTION AT NO ADDITIONAL COST TO THE CONTRACT.
- 16. ALL SUITABLE BORROW MATERIAL FOR BACK FILL OF THE SITE SHALL BE INCLUDED IN THE BID. EXCESS TOPSOIL AND UNSUITABLE MATERIAL SHALL BE DISPOSED OF OF SITE AT LOCATIONS APPROVED BY GOVERNING AGENCIES AT NO ADDITIONAL COST TO THE CONTRACT.
- FOUNDATION DESIGN IS BASED UPON 1,500 PSF ALLOWABLE BEARING PRESSURE. INDEPENDENT SOILS TESTING BY A LICENSED GEOTECHNICAL ENGINEER IS STRONGLY RECOMMENDED TO VERIFY SOIL BEARING CAPACITY, SLOPE STABILITY, AND ALL OTHER APPLICABLE SOILS PARAMETERS.

STRUCTURAL STEEL NOTES

 ALL STEEL WORK SHALL BE IN ACCORDANCE WITH THE LATEST EDITION OF THE AISC MANUAL OF STEEL CONSTRUCTION. STEEL SECTIONS SHALL BE IN ACCORDANCE WITH ASTM AS INDICATED BELOW:

W-SHAPES: ASTM A992, 50 KSI ANGLES, BARS CHANNELS: ASTM A36, 36 KSI HSS SECTIONS: ASTM 500, 46 KSI PIPE SECTIONS: ASTM 503-8 35 KSI

- 2. ALL EXTERIOR EXPOSED STEEL AND HARDWARE SHALL BE HOT DIPPED GALVANIZED.
- ALL WELDING SHALL BE PERFORMED USING FOXX: ELECTRODES AND WELDING SHALL CONFORM TO AISC, WHERE FILLET WELD SIZES ARE NOT SHOWN, PROVIDE THE MINIMUM SIZE PER TABLE 12.4 IN THE AISC "MANUAL OF STEEL CONSTRUCTION", PANHED SUPFACES SHALL BETOUCHED UP, ALL WELDING SHALL BE PERFORMED IN A M-PRROVED SHOT.
- 4. ALL BOLTS FOR STEEL TO STEEL CONNECTIONS TO BE PER ASTM A325, HOLES TO BE 1/16" DIA.
- NON-STRUCTURAL CONNECTIONS FOR STEEL GRATING MAY USE 5/8"Ø ASTM A 307 BOLTS LINI ESS NOTED OTHERWISE
- 6. FIELD MODIFICATIONS ARE TO BE COATED WITH ZINC ENRICHED PAINT.
- 7. HOLES TO RECEIVE EXPANSION/WEDGE ANCHORS SHALL CONFORM TO MANURACTURER'S RECOMMENDATION FOR EMBEDMENT DEPTH AND DIAMETER. LOCALE AND AVOID CUITING EXISTING REBAR OR TENDONS WHEN DRILLING HOLES IN ELEVATED CONCRETE SLABS OR CONCRETE WALLS.
- USE AND INSTALLATION OF CONCRETE EXPANSION/WEDGE ANCHOR, SHALL BE PER ICC &
 MANUFACTURER'S WRITTEN RECOMMENDED PROCEDURES, THIRD PARTY SPECIAL
 INSPECTION IS REQUIRED FOR CONCRETE EXPANSION ANCHORS (ILE: SIMPSON
 STRONG-BOLT 2 WEDGE ANCHORS PER ESR-3037), INSTALLATION OF WEDGE ANCHORS IN
 MASS/NBY IS NOT PERMITTED.









AWN BY: C

DRAWING VERSION
VER. DATE DESCRIPTION
1 01/16/25 PRELIM CONST DRAWINGS

LICENSER

PROJECT INFORMATION

MOSSYROCK

262 SKYVIEW DR MOSSYROCK, WA 98564

SHEET TITLE

GENERAL NOTES

SHEET NO.

GN1.0

STRUCTURAL CONCRETE NOTES

- 1. ALL CONCRETE WORK SHALL BE IN ACCORDANCE WITH THE ACI 318-14 AND THE SPECIFICATION FOR CAST-IN-PLACE CONCRETE.
- 2. ALL CONCRETE FOR SLABS ON GRADE, SHELTER FOUNDATION, AND PIER FOUNDATIONS FOR FENCES, ICE BRIDGE AND H-FRAME SHALL HAVE A MINIMUM COMPRESSIVE STRENGTH [c'=3,000 PS] AT 28 DAYS LINESS NOTED OTHERWISE, SPECIAL INSPECTION REQUIRED AS NOTED.
- 3. REINFORCING STEEL SHALL CONFORM TO ASTM A 615. GRADE 60. DEFORMED LINLESS NOTED OTHERWISE. WELDED WIRE FABRIC SHALL CONFORM TO ASTM A 185 WELDED STEEL WIRE FABRIC UNLESS NOTED OTHERWISE. SPLICES CLASS "B" AND ALL HOOKS SHALL BE STANDARD UNLESS NOTED OTHERWISE.
- 4. THE FOLLOWING MINIMUM CONCRETE COVER SHALL BE PROVIDED FOR REINFORCING STEEL UNLESS

CONCRETE CAST AGAINST FARTH....

CONCRETE EXPOSED TO EARTH OR WEATHER: #6 AND LARGER......2 IN. #5 AND SMALLER & WWF......1 1/2 IN.

CONCRETE NOT EXPOSED TO EARTH OR WEATHER OR NOT CAST AGAINST THE GROUND: SLAB AND WALL......3/4 IN.
BEAMS AND COLUMNS......1 1/2 IN.

- A 3/4" CHAMFER SHALL BE PROVIDED AT ALL EXPOSED EDGES OF CONCRETE U.N.O. IN ACCORDANCE WITH ACI 301, LATEST EDITION, SECTION 4.
- 6. HOLES TO RECEIVE EXPANSION/WEDGE ANCHORS SHALL BE 1/8" L'ARGER IN DIAMETER THAN THE ANCHOR BOLT, DOWEL OR ROD AND SHALL CONFORM TO MANUFACTURER'S RECOMMENDATION FOR EMBEDMENT DEPTH OR AS SHOWN ON THE DRAWINGS. L'OCATÉ AND AVOID CUTTING EXISTING REBAR WHEN DRILLING HOLES IN ELEVATED CONCRETE SLABS.
- 7. USE AND INSTALLATION OF CONCRETE ADHESIVE AND EXPANSION/WEDGE ANCHORS SHALL BE PER ICC & MANUFACTURER'S WRITTEN RECOMMENDED PROCEDURES
- 8. FOUNDATION DESIGN IS BASED ON PRESUMPTIVE SOIL PARAMETERS. IT IS STRONGLY RECOMMENDED THAT INDEPENDENT SOILS TESTING BE PERFORMED BY A LICENSED GEOTECHNICAL ENGINEER TO VERIFY SOIL BEARING CAPACITY, SLOPE STABILITY, AND ALL OTHER RELATED SOIL PARAMETERS.

SPECIAL INSPECTION NOTES

- CONTRACTOR SHALL PROVIDE REQUIRED SPECIAL INSPECTIONS PERFORMED BY AN INDEPENDENT INSPECTOR, AFFROVED BY CARRIER AND THE LOCAL JURISDICTION, AS REQUIRED BY IBC SECTION 1704 AND 1705 FOR THE FOLLOWING:
- - . ALL HIGH STRENGTH BOLT INSTALLATIONS; BOLTING INSPECTION TASKS SHALL BE IN ACCORDANCE WITH TABLES N5.6-1, N5.6-2, AND N5.6-3 PER AISC 360-10.
- ii. FIELD WELDING (IF UTILIZED).
- B. BOLTS AND ANCHORS IN CONCRETE: RETROFIT ANCHORS IN CONCRETE (ASHESIVE/EPOXY, EXPANSION, WEDGE, OR SCREW TYPE ANCHORS): INSPECT SIZE, LENGTH, CLEANLINESS, AND INSTALLATION PER MANUFACTURER'S RECOMMENDATIONS.
- VERIFICATION AND INSPECTION OF CONCRETE CONSTRUCTION SHALL BE IN ACCORDANCE WITH IBC SECTION 1705, TABLE 1705.3

SPECIAL INSPECTION NOTES

- PROVIDE SPECIAL INSPECTIONS FOR OTHER ITEMS NOTED ON DRAWINGS TO CONFIRM COMPLIANCE WITH CONTRACT DOCUMENTS
- THE SPECIAL INSPECTOR SHALL PROVIDE A COPY OF THE REPORT TO THE OWNER, ARCHITECT, STRUCTURAL ENGINEER, CONTRACTOR, AND BUILDING OFFICIAL
- 4. CONTINUOUS THIRD PARTY SPECIAL INSPECTION REQUIRED FOR ALL BELZONA 1111 MOUNTED PLATES AND

INSPECTION OF HIGH-STRENGTH BOLTING (PER AISC 360-16, SECTION N5):

OBSERVATION OF BOLITING OPERATIONS SHALL BE THE PRIMARY METHOD LISED TO CONFIRM THAT THE MATERIALS, PROCEDURES AND WORKMANSHIP INCORPORATED IN CONSTRUCTION ARE IN CONFORMANCE WITH THE CONSTRUCTION DOCUMENTS AND THE PROVISIONS OF THE RCSC SPECIFICATION.

- (1) FOR SNUG-TIGHT JOINTS, PRE-INSTALLATION VERIFICATION TESTING AS SPECIFIED IN TABLE N5.6-1 AND MONITORING OF THE INSTALLATION PROCEDURES AS SPECIFIED IN TABLE N5.6-2 ARE NOT APPLICABLE. THE QCI AND QAI NEED NOT BE PRESENT DURING THE INSTALLATION OF FASTENERS IN SNUG-TIGHT JOINTS.
- (2) FOR PRETENSIONED JOINTS AND SUP-CRITICAL JOINTS, WHEN THE HISTALTERS IS SING THE TURN-OF-NUT WHITHOO WITH MATCHMARKING TECHNIQUES, THE DIRECT-TENSION-HIDICATOR METHOD. OR THE TWIST-OF-TYPE TENSION CONTROL BOTH METHOD MONITORING OF BOTH PRETENSIONING PROCEDURES SHALL BE AS SPECIFIED IN TABLE NS.6-2. THE QCI AND QAI NEED NOT BE PRESENT DURING THE INSTALLATION OF FASTENERS WHEN THESE METHODS ARE USED BY THE INSTALLER.
- (3) FOR PRETENSIONED JOINTS AND SUP-CRITICAL JOINTS, WHEN THE INSTALLER IS USING THE CALIBRATED WERNCH METHOD OR THE TURN-O-NUT METHOD WITHOUT MATCHMARKING, MONITORING OF BOLT PRETENSIONED FOR SHALL BE AS SPECIFIED IN TABLE NS.6.2. THE GOLAND GAI SHALL BE ENGAGED IN THEIR ASSIGNED INSPECTION DUTIES DURING INSTALLATION OF FASTENERS WHEN THESE METHODS ARE USED BY THE INSTALLER.

AS A MINIMUM, BOLTING INSPECTION TASKS SHALL BE IN ACCORDANCE WITH TABLES N5.6-1, N5.6-2 AND N5.6-3. IN THESE TABLES. THE INSPECTION TASKS ARE AS FOLLOWS:

- OBSERVE THESE ITEMS ON A RANDOM BASIS. OPERATIONS NEED NOT BE DELAYED PENDING THESE INSPECTIONS.
- PERFORM THESE TASKS FOR EACH BOLTED CONNECTION.
- PERTORN THESE TASKS FOR EACH BOULD CONNECTION.

 QUALITY CONTROL TASKS TO BE PERFORMED BY STEEL FABRICATOR OR ERECTOR

 QUALITY ASSURANCE TASKS TO BE PERFORMED BY A SPECIAL INSPECTION AGENCY OR INDIVIDUALS

 DEFINED BY AWS BS.1. OR INDIVIDUALS QUALIFIED UNDER THE PROVISIONS OF AWS D1.1/D1.1M SUBCLAUSE 6.1.4

TABLE NE 4 1. INICDECTION TACKS DDIOD TO BOLTING

TABLE N5.6-1; INSPECTION TASKS PRIOR TO BO	LIIIN	G
INSPECTION TASKS PRIOR TO BOLTING	QC	QA
MANUFACTURER'S CERTIFICATIONS AVAILABLE FOR FASTENER MATERIALS	0	Р
FASTENERS MARKED IN ACCORDANCE WITH ASTM REQUIREMENTS	0	0
PROPER FASTENERS SELECTED FOR THE JOINT DETAIL (GRADE, TYPE, BOLT LENGTH IF THREADS ARE TO BE EXCLUDED FROM SHEAR PLANE)	0	0
PROPER BOLTING PROCEDURE SELECTED FOR JOINT DETAIL	0	0
CONNECTING ELEMENTS, INCLUDING THE APPROPRIATE FAYING SURFACE CONDITION AND HOLE PREPARATION, IF SPECIFIED, MEET APPLICABLE REQUIREMENTS	0	0
PRE-INSTALLATION VERIFICAITON TESTING BY INSTALLATION PERSONNEL OBSERVED AND DOCUMENTED FOR FASTENER ASSEMBLIES AND METHODS USED	Р	0
PROPER STORAGE PROVIDED FOR BOLTS, NUTS, WASHERS, AND OTHER FASTENER COMPONENTS	0	0
TABLE N5.6-2; INSPECTION TASKS DURING BOL	TING	3
INSPECTION TASKS DURING BOLTING	QC	QA
INSPECTION TASKS DURING BOLTING FASTENER ASSEMBLIES, OF SUITABLE CONDITION, PLACED IN ALL HOLES AND WASHERS (IF REQUIRED) ARE POSITIONED AS REQUIRED WASHERS (IF REQUIRED) ARE POSITIONED AS REQUIRED	QC O	QA O
FASTENER ASSEMBLIES, OF SUITABLE CONDITION, PLACED IN ALL HOLES AND		
FASTENER ASSEMBLIES, OF SUITABLE CONDITION, PLACED IN ALL HOLES AND WASHERS (IF REQUIRED) ARE POSITIONED AS REQUIRED JOINT BROUGHT TO THE SNUG-TIGHT CONDITION PRIOR TO THE PRETENSIONING	0	0
FASTENER ASSEMBLIES, OF SUITABLE CONDITION, PLACED IN ALL HOLES AND WASHERS (IF REQUIRED) ARE POSITIONED AS REQUIRED JOINT BROUGHT TO THE SNUG-TIGHT CONDITION PRIOR TO THE PRETENSIONING OPERATION	0	0
FASTENER ASSEMBLIES, OF SUITABLE CONDITION, PLACED IN ALL HOLES AND WASHERS, IF REQUIRED) ARE POSITIONED AS REQUIRED JOINT BROUGHT TO THE SNUG-TIGHT CONDITION PRIOR TO THE PRETENSIONING OPERATION FASTENER COMPONENT NOT TURNED BY THE WRENCH PREVENTED FROM ROTATING FASTENERS ARE PRETENSIONED IN ACCORDANCE WITH THE RCSCSPECIFICATION,	0 0	0 0
FASTENER ASSEMBLES, OF SUITABLE CONDITION, PLACED IN ALL HOLES AND WASHERS, (IF REQUIRED) ARE POSITIONED AS REQUIRED JOINT BROUGHT OTHE SNUG-TIGHT CONDITION PRIOR TO THE PRETENSIONING OPERATION FASTENER COMPONENT NOT TURNED BY THE WRENCH PREVENTED FROM ROTATING FASTENERS ARE PRETENSIONED IN ACCORDANCE WITH THE RCSCSPECIFICATION, PROGRESSING SYSTEMATICALLY FROM THE MOST RIGID POINT TOWARD THE FREE EDGES	0 0	0 0
FASTENER ASSEMBLIES, OF SUITABLE CONDITION, PLACED IN ALL HOLES AND WASHERS (IF REQUIRED) ARE POSITIONED AS REQUIRED JOINT BROUGHT TO THE SNUG-TIGHT CONDITION PRIOR TO THE PRETENSIONING OPERATION FASTENER COMPONENT NOT TURNED BY THE WRENCH PREVENTED FROM ROTATING FASTENERS ARE PRETENSIONED IN ACCORDANCE WITH THE RESCSPECIFICATION, PROGRESSING SYSTEMATICALLY FROM THE MOST RIGID POINT TOWARD THE FREE EDGES TABLE N5.6-3; INSPECTION TASKS AFTER BOLT	o o o	0 0
FASTENER ASSEMBLIES, OF SUITABLE CONDITION, PLACED IN ALL HOLES AND WASHERS (IF REQUIRED) ARE POSITIONED AS REQUIRED JOINT BROUGHT TO THE SNUG-TIGHT CONDITION PRIOR TO THE PRETENSIONING OPERATION FASTENER COMPONENT NOT TURNED BY THE WRENCH PREVENTED FROM ROTATING FASTENERS ARE PRETENSIONED IN ACCORDANCE WITH THE RESOSPECIFICATION, PROGRESSING SYSTEMATICALLY FROM THE MOST RIGID POINT TOWARD THE FREE EDGES TABLE N5.6-3; INSPECTION TASKS AFTER BOLT INSPECTION TASKS DURING BOLTING	0 0 0 0 ING	0 0 0

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DRAWING ARREVIATIONS









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VER.	VER. DATE DESCRIPTION		
1	01/16/25	PRELIM CONST DRAWINGS	

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PROJECT INFORMATION MOSSYROCK


262 SKYVIEW DR MOSSYROCK, WA 98564


SHEET TITLE

GENERAL NOTES


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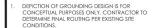
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- GROUNDING SHALL COMPLY WITH LATEST EDITION OF THE NATIONAL ELECTRICAL CODE.
- 3. ALL GROUNDING SHALL CONFORM TO THE CURRENT
- 4. MINIMUM BENDING RADIUS FOR GROUND CONDUCTOR IS 8", WHEN BENDING IS NECESSARY. GROUND CONDUCTORS ARE TO BE AS STRAIGHT AS
- ALL ABOVE GRADE GROUND LEADS TO BE SHEATHED IN CARFLEX-X-FLEX™ FLEXIBLE CONDUIT OR APPROVED EQUAL.
- ALL GROUND BAR CONNECTIONS ARE TO BE 2 HOLE LUG COMPRESSION TYPE: STACKED CONNECTIONS ARE NOT ACCEPTABLE. BACK TO BACK CONNECTIONS ON OPPOSITE SIDES OF THE GROUND BAR WILL BE PERMITTED.
- NO SPLICES PERMITTED IN GROUND CONDUCTORS.
- ALL GROUNDING CONNECTORS TO BE CLEAN AND
 FREE OF PAINT AT THEIR MATING SURFACES AND
 INSTALLED PER MANUFACTURER'S RECOMMENDATIONS.
 USE PENETROX OR APPROVED EQUAL ANTIOXIDANT
 OFFICE.
- ENSURE ALL MECHANICAL CONNECTORS ARE TORQUED TO THE MANUFACTURER'S SPECIFIED VALUES.
- 10. MULTIPLE BONDS ON GROUND RODS TO BE SEPARATED
- MAXIMUM RESISTANCE OF THE COMPLETED GROUND SYSTEM SHALL NOT EXCEED A RESISTANCE OF 5 OHMS TO EARTH.
- GROUND WIRES SHALL NOT BE INSTALLED THROUGH HOLES IN ANY METAL OBJECTS OR SUPPORTS TO PRECLUDE ESTABLISHING A "CHOKE" POINT.
- 13. FERROUS METAL CLIPS WHICH COMPLETELY SURROUND THE GROUND WIRE SHALL NOT BE USED. METAL CLIPS THAT DO NOT COMPLETELY SURROUND THE GROUND WIRE OR PLASTIC CLIPS ARE ACCEPTABLE.
- 14. ALL OUTDOOR CONNECTIONS TO BE EXOTHERMIC CADWELD, INTERIOR CONNECTIONS CAN BE A PROPERLY APPLIED CRIMP TYPE UNLESS OTHERWISE SPECIFIED.
- 15. GROUND BARS SHALL NOT BE FIELD MODIFIED.
- 16. ALL HORIZONTAL FENCE SECTIONS TO BE GROUNDED WITH 8" SINGLE BARREL GROUND STRAPS.
- GROUND RING BURIAL DEPTH SHALL BE 24" AND HAVE A NON-DIRECTIONAL SPLICE.
- 18. A CERTIFED CONTRACTOR WILL MAKE ALL MEASUREMENTS REQUIRED TO TEST THE GROUNDING SYSTEM, USING A MEGGER OR EQUIVALENT. THE ACCEPTABLE RESISTANCE MEASURED FOR THE GROUNDING SYSTEM WILL NOT EXCEED 5 OHMS RESISTANCE. INKEE DISTANCES SHALL BE USED: 1 AT 100 FEET, 1 AT 70 FEET, AND 1 AT 35 FEET. THESE DISTANCES ARE SUBJECT TO A SITE BY SITE BASIS, VERIZON WIRELESS SHALL BE GIVEN 24 HOURS NOTICE BEFORE TESTING IS TO BE DONE. THE COST ASSOCIATED WITH GROUND TESTING WILL BE AT THE EXPENSE OF THE CONTRACTOR.
- 19. PROVIDE #2 TW GREEN JUMPER FROM EACH CABLE
 BRIDGE POST TO CABLE BRIDGE CHANNEL

LEGEND

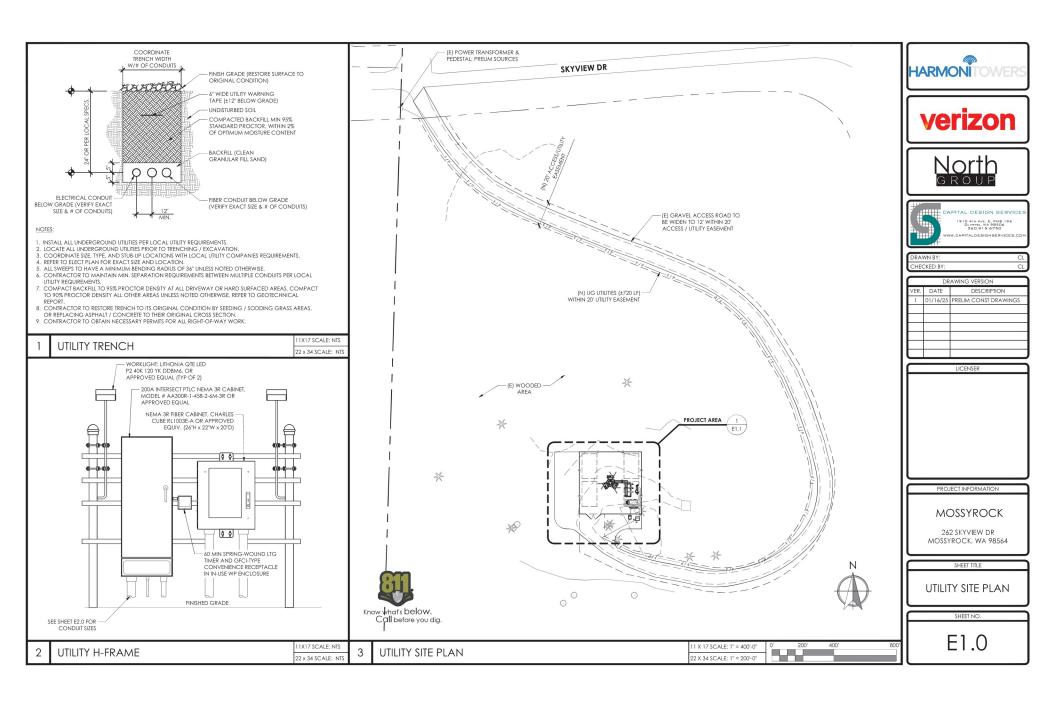GROUND TEST WELL

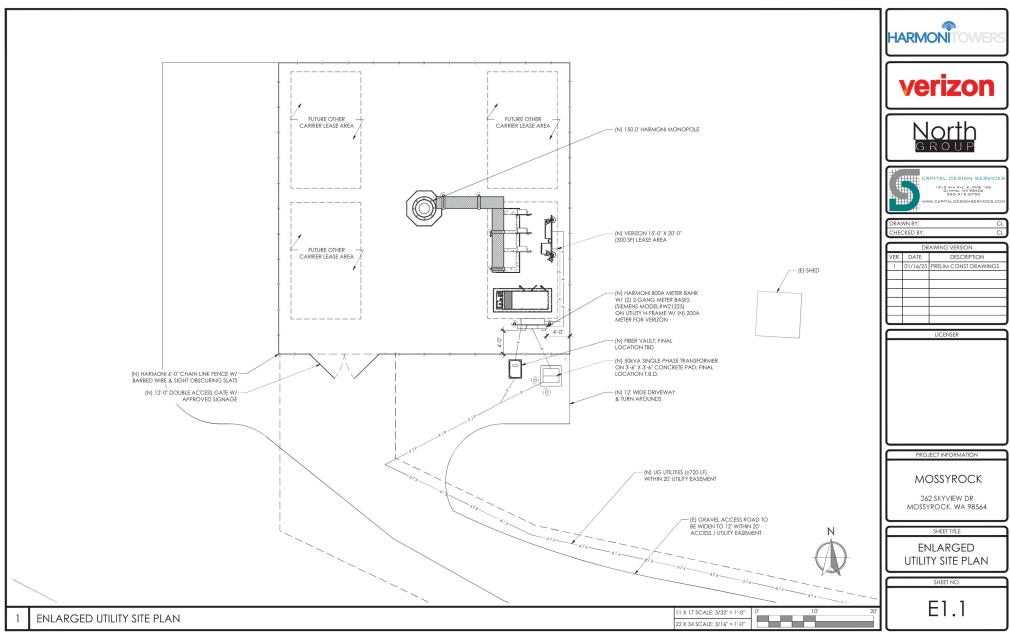GROUND ROD


■ CAD WELD CONNECTION

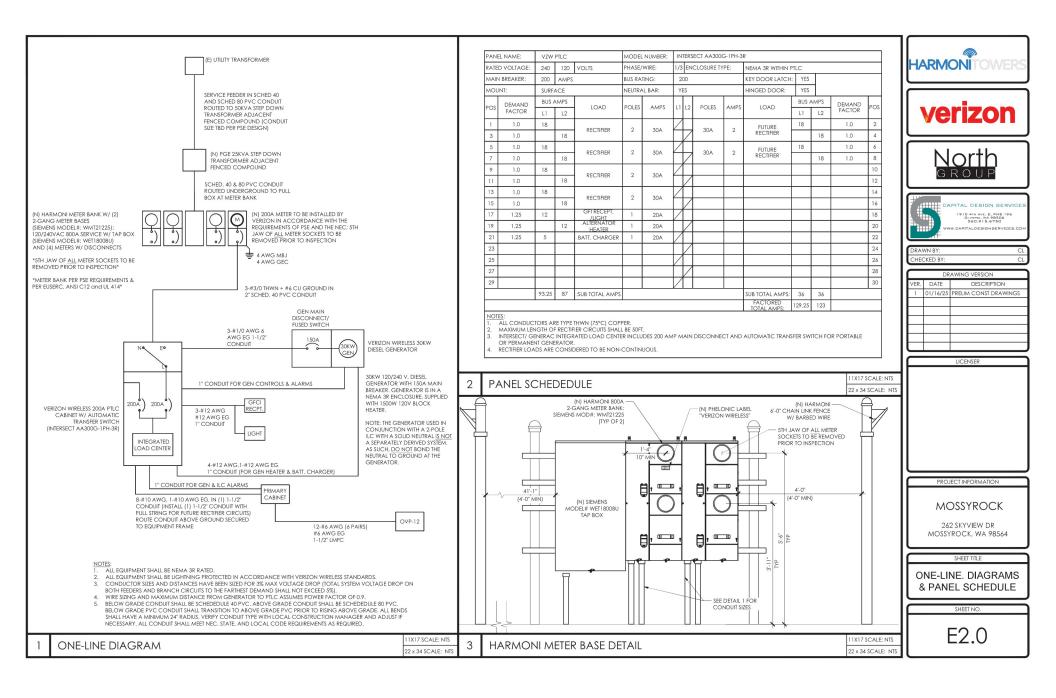▲ MECHANICAL CONNECTION (DOUBLE HOLE LUG)

CONNECT PER MFR SPECIFICATIONS

GB GROUND BAR



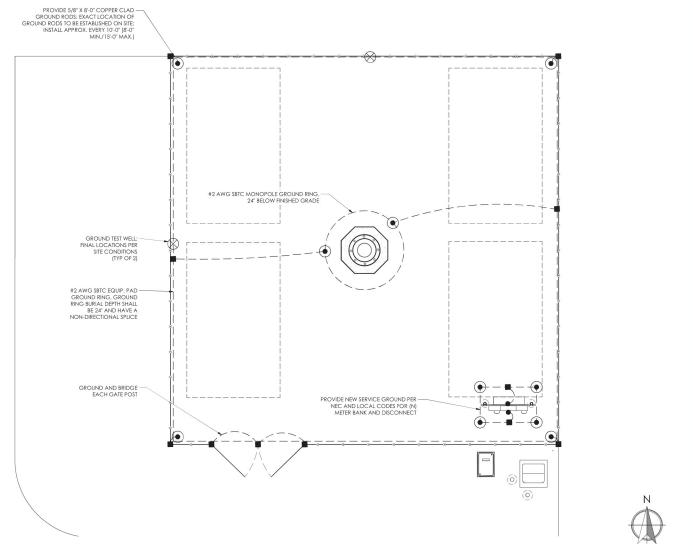









DRAWN BY: CL CHECKED BY: CL

DRAWING VERSION					
VER.	VER. DATE DESCRIPTION				
1	01/16/25	PRELIM CONST DRAWINGS			

LICENSER

PROJECT INFORMATION

MOSSYROCK

262 SKYVIEW DR MOSSYROCK, WA 98564

SHEET TITLE


GROUNDING PLAN

SHEET NO.

E3.0

1X17 SCALE: NTS

22 x 34 SCALE: NT

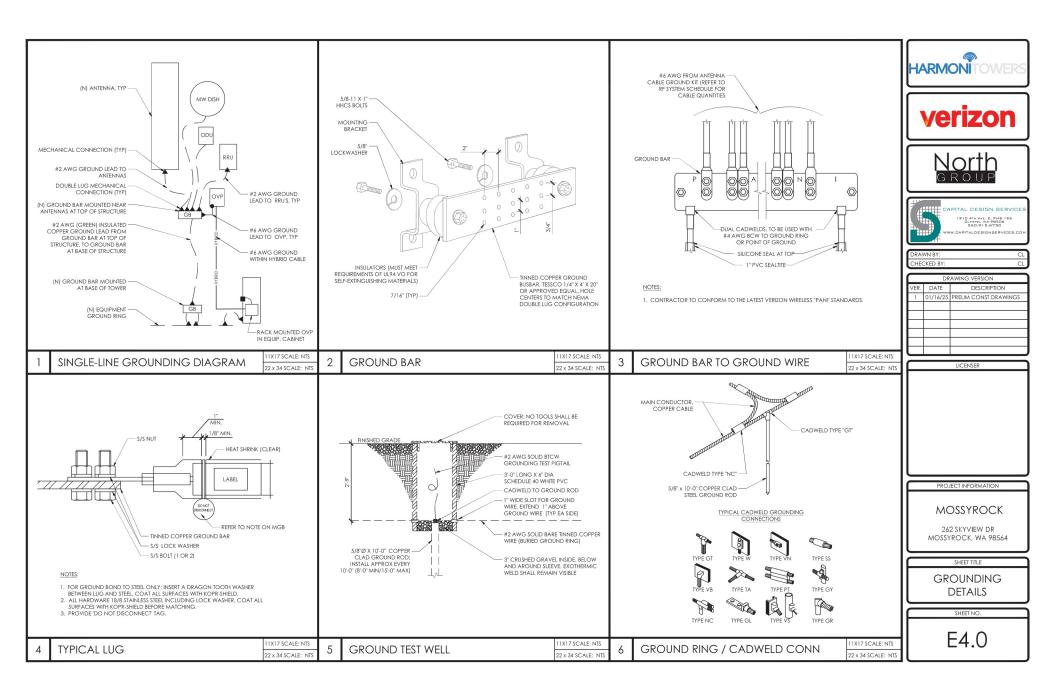

- ELECTRICAL CONTRACTOR SHALL SUPPLY AND INSTALL ANY/ALL ELECTRICAL WORK INDICATED.
 ANY/ALL CONSTRUCTION SHALL BE IN ACCOPDANCE WIDDRAWINGS AND ANY/ALL APPLICABLE
 SPECIFICATIONS. IF ANY PROBLEMS ARE ENCOUNTERED BY COMPLYING WITH THESE REQUIREMENTS,
 CONTRACTOR SHALL NOTIFY VW CONSTRUCTION MANAGER AS SOON AS POSSIBLE AND SHALL NOT
 PROCEED WITH THAT FORTION OF WORK, UNTIL THE CONSTRUCTION MANAGER HAS DIRECTED THE
 CORRECTIVE ACTIONS TO BE TAKEN.
- 2. ELECTRICAL CONTRACTOR SHALL VISIT THE JOB SITE AND FAMILIARIZE HIMSELF WITH ANY/ALL CONDITIONS AFFECTING THE INSTALLATION OF PROPOSED ELECTRICAL AND COMMUNICATION CIRCIDS AND EQUIPMENT AND SHALL MAKE PROVISIONS FOR THE COST THEREOF. ALL EXISTING CONDITIONS OF EXISTING ELECTRICAL EQUIP, LIGHT FIXTURES, ETC. IF ANY, THAT ARE PART OF THE FINAL SYSTEM, SHALL BE VERRIEDE BY THE CONTRACTOR, PROJOT TO THE SUBMITTAL OF HIS ID. FAILURE TO COMPLY WITH THIS PARAGRAPH WILL IN NO WAY RELIEVE CONTRACTOR OF PERFORMING ALL WORK IN PROSESSARY FOR A COMPILET AND WORKING SYSTEM.
- ALL WORK SHALL BE PERFORMED IN ACCORDANCE WITH THE LATEST EDITION OF THE NEC AS
 ADOPTED BY THE LOCAL AH JAS WELL AS ALL LOCAL CODES AND ORDINANCES OF THE LOCAL
 AUTHORITY HAVING JURISDICTION. THE WORK SHALL BE GOVERNED BY:
 - A III IINDERWRITERS LABORATORIES
 - B. NEC NATIONAL ELECTRICAL CODE
- C. NEMA NATIONAL ELECTRICAL MANUFACTURERS ASSOCIATION STANDARDS
- D. OSHA REQUIREMENTS OF THE OCCUPATIONAL SAFETY AND HEALTH ACT
- E. IBC INTERNATIONAL BUILDING CODE
- F. NFPA -- NATIONAL FIRE PROTECTION ASSOCIATION
- G. IEEE INSTITUTE OF ELECTRICAL & ELECTRONICS ENGINEERS STANDARDS
- DO NOT SCALE ELECTRICAL DRAWINGS, REFER TO DIMENSIONED SITE PLANS AND ELEVATIONS FOR EXACT LOCATIONS OF ALL EQUIPMENT AND CONFIRM WITH CONSTRUCTION MANAGER ANY SIZES AND LOCATIONS WHEN UNCLEAR.
- 5. EXISTING SERVICES: CONTRACTOR SHALL NOT INTERRUPT EXISTING UTILITY SERVICES WITHOUT WRITTEN PERMISSION OF PROPERTY OWNERS.
- CONTRACTOR SHALL PAY FOR ANY/ALL PERMITS, FEES, INSPECTIONS AND TESTING, CONTRACTOR SHALL OBTAIN PERMITS AND APPROVED SUBMITTALS PRIOR TO ORDERING EQUIPMENT OR STARTING THE WORD.
- THE TERM "PROVIDE" USED IN CONSTRUCTION DOCUMENTS AND SPECIFICATIONS SHALL BE UNDERSTOOD TO MEAN THAT THE CONTRACTOR SHALL FURNISH, INSTALL AND CONNECT.
- CONTRACTOR SHALL CONFIRM WITH LOCAL ELECTRIC UTILITY COMPANY ANY/ALL REQUIREMENTS, INCLUDING BUT NOT LIMITED TO: LUG SUR RESTRICTIONS, CONDIE TERRY, SIZE OF FRANSFORMERS, SCHEDULED DOWNTIME FOR THE CONNERS' CONFIRMATION, ETC. ANY/ALL CONFLICTS SHALL BE BROUGHT TO THE ATTENTION OF THE CONSTRUCTION MAN AGE PRIOR TO BE GEINNING ANY WORK.
- MINIMUM WIRE SIZE SHALL BE #12 AWG, NOT INCLUDING CONTROL WIRING, UNLESS NOTED OTHERWISE. ALL CONDUCTORS SHALL BE COPPER WITH XHHW-2 INSULATION.
- OUTLET BOXES SHALL BE CAST ALLOY WITH THREADED HUBS IN WET/DAMP LOCATIONS AND SPECIAL ENCLOSURES FOR OTHER CLASSIFIED AREAS AS SHOWN ON THE DRAWINGS.
- 11. IT IS NOT THE INTENT OF THESE PLANS TO SHOW EVERY MINOR DETAIL OF THE CONSTRUCTION. CONTRACTOR IS EXPECTED TO PURNISH AND INSTALL ALL ITEMS FOR A COMPLETE ELECTRICAL SYSTEM AND PROVIDE ALL REQUIREMENTS FOR THE EQUIPMENT TO BE PLACED IN PROPER WORKING ORDER.
- ELECTRICAL SYSTEM SHALL BE AS COMPLETELY AND EFFECTIVELY GROUNDED AS REQUIRED BY SPECIFICATIONS SET FORTH BY VERIZON WIRELESS.
- 13. ALL WORK SHALL BE PERFORMED BY A LICENSED ELECTRICAL CONTRACTOR IN A FIRST CLASS, WORKMANLIKE MANNER. THE COMPLETED SYSTEM SHALL BE FULLY OPERATIVE AND SUBJECT TO RECILILATORY INSPECTION AND A PEROVAL BY CONSTRUCTION MANAGER.
- 14. ALL WORK SHALL BE COORDINATED WITH OTHER TRADES TO AVOID INTERFERENCE WITH THE
- 15. CONTRACTOR SHALL GUARANTEE ANY/ALL MATERIALS AND WORK FREE FROM DEFECTS FOR A PERIOD OF NOT LESS THAN TWO YEAR FROM DATE OF CUSTOMER'S ACCEPTANCE.
- 16. THE CORRECTION OF ANY DEFECTS SHALL BE COMPLETED WITHOUT ANY ADDITIONAL CHARGE WITHIN 48 HOURSOF NOTICE AND SHALL INCLUDE THE REPLACEMENT OR THE REPAIR OF ANY OTHER PHASE OF THE INSTALLATION WHICH MAY HAVE BEEN DAMAGED THEREIN.
- ADEQUATE AND REQUIRED LIABILITY INSURANCE SHALL BE PROVIDED BY THE CONTRACTOR FOR PROTECTION AGAINST PUBLIC LOSS AND ANY/ALL PROPERTY DAMAGE FOR THE DURATION OF WORK.
- PROVIDE AND INSTALL CONDUIT, CONDUCTORS, PULL WIRES, BOXES, COVER PLATES AND DEVICES FOR ALL OUTLETS AS INDICATED.
- 19. DITCHING AND BACK FILL CONIRACTOR SHALL PROVIDE FOR ALL UNDERGROUND INSTALLED CONDUIT AND/OR CABLES INCLUDING EXCAVATION, BACKFILLING, COMPACTION AND REPAIR OF SUPFACE TO ORIGINAL CONDITION, REFER TO DRAWING DETAIL AS WELL AS NOTES AND REQUIREMENTS: EXCAVATION, AND BACKFILING.
- 20. MATERIALS, PRODUCTS AND EQUIPMENT, INCLUDING ALL COMPONENTS THEREOF, SHALL BE NEW, SHALL APPEA ON THE LIST OF LIL. APPROVED ITEMS AND SHALL MEET OR EXCEED THE REQUIREMENTS OF THE NEC. NEMA. AND IFFE.

- 21. CONTRACTOR SHALL SUBMIT SHOP DRAWINGS OR MANUFACTURES CATALOG INFORMATION OF LIGHTING FIXTURES, TIMER SWITCHES AND ALL OTHER ELECTRICAL ITEMS PRIOR TO INSTALLATION FOR APPROVAL BY THE CONSTRUCTION MANAGER.
- 22. ANY CUTTING OR PATCHING DEBMED NECESSARY FOR ELECTRICAL WORK SHALL BE THE RESPONSIBILITY OF THE ELECTRICAL CONTRACTORS, SHALL BE INCLUDED IN THE PROPOSED PRICE FOR THE WORK AND SHALL BE PERFORMED TO THE SATISFACTION OF THE CONSTRUCTION MANAGER FOR FINAL ACCEPTANCE.
- 23. THE ELECTRICAL CONTRACTOR SHALL LABEL ALL PANELS WITH ONLY TYPEWRITTEN DIRECTORIES. ALL ELECTRICAL WIRING SHALL BE THE RESPONSIBILITY OF THE ELECTRICAL CONTRACTOR.
- DISCONNECT SWITCHES REQUIRED SHALL BE H.P. RATED HEAVY-DUTY, QUICK-MAKE AND QUICK-BREAK ENCLOSURES. AS REQUIRED BY EXPOSURE TYPE.
- 25. ALL CONNECTIONS SHALL BE MADE WITH A PROTECTIVE COATING OF AN ANTI-ONDE COMPOUND SUCH AS TWO-ONDE AT DEARBORNE CHEMICAL CO., COAT ALL WIRE SURFACES BEFORE CONNECTING, EXPOSED COPPER SURFACES, INCLUDING GROUND BARS, SHALL BE ITERATED - NO
- 28. RACEWAYS: CONDUIT SHALL BE SCHEDULE 40 PVC MEETING OR EXCEEDING NEMA TC2- 1990 OR OTHERWISE AS SHOWN ON DEPARMINGS. COMTRACTOR SHALL PLUG AND CAP EACH END OF SPARE AND EMPTY CONDUITS AND PROVIDE TWO SEPARATE PULLIA PES- 200 LBS TEST POLYETHYLENE CORD. ALL CONDUIT BERDIS SHALL BE A MINIMUM OF 2FT. RADDUIS, RSS CONDUITS WHEN SPECIFIED, SHALL MEET UL-6 FOR CALVANUED STEEL. ALL FITTINGS SHALL BE SUITABLE FOR USE WITH THREADED RIGID CONDUIT. COAT ALL THREADS WITH SHEET ZINC OR TOOLD CALV.
- 27 SUPPORT OF ALL FLECTRICAL WORK SHALL BE AS REQUIRED BY NEC
- 28. CONDUCTORS: CONTRACTOR SHALL USE 98% CONDUCTIVITY COPPER WITH TYPE XHHW-2 INSULATION, 600 YOLT, COLOR CODED. USE SOLID CONDUCTORS FOR WIRE UP TO AND INCLUDING NO. 8 AWG. USE STRANDED CONDUCTORS FOR WIRE LARGER THAN NO. 8 AWG.
- 29. CONNECTORS FOR POWER CONDUCTORS: CONTRACTOR SHALL USE PRESSURE-TYPE INSULATED TWIST-ON CONNECTORS FOR NO. 10 AWG AND SMALLER. USE SOLDERLESS MECHANICAL TERMINAL LUGS FOR NO. 8 AWG AND LARGER.
- SERVICE: 240/120V, SINGLE PHASE, 3 WIRE CONNECTIONS AVAILABLE FROM UTILITY COMPANY. OWNER OR OWNERS AGENT WILL APPLY FOR POWER.
- TELEPHONE SERVICE: CONTRACTOR SHALL PROVIDE EMPTY CONDUITS WITH MULE TAPE AS INDICATED ON DRAWINGS.
- 32. ELECTRICAL AND TELCO RACEWAYS TO BE BURIED A MINIMUM OF 2' DEPTH.
- 33. CONTRACTOR SHALL PLACE TWO LENGTHS OF WARNING TAPE AT A DEPTH OF 12" BELOW GROUND AND DIRECTLY ABOVE ELECTRICAL AND TELCO SERVICE CONDUITS. CAUTIONS TAPE TO READ "CAUTION BURIED ELECTRIC" OR "BURIED TELECOM".
- 34. ALL BOLTS SHALL BE STAINLESS STEEL.
- 35. CONTRACTOR SHALL COORDINATE WITH LOCAL POWER COMPANY FOR REQUIREMENTS OF POWER SERVICE ELATERAL TO THE METER BASE. POWER SERVICE REQUIREMENT IS COMMERCIAL. AC NOMINAL 120/208 VOLI OR 120/24 VOLI, SINGLE PHASE WITH 200 AMP RATING WHEN REQUIRED.
- 36. CONTRACTOR SHALL COORDINATE WITH LOCAL TELEPHONE COMPANY FOR FIBER OPTIC CABLE SERVICE REQUIREMENTS TO TERMINATE AS SHOWN ON DRAWINGS.
- 37. UNDERGROUND POWER AND TELCO SERVICE LINES SHALL BE ROUTED IN A COMMONTRENCH, ALL UNDERGROUND CONDUIT STALL BE PVO SCHEDULE 40 AND CONDUIT EXPOSED ABOVE GROUND SHALL BE GALVANIZED RIGID STEEL TUBING UNLESS OTHERWISE INDICATED.
- 38. ALL FIBER OPTIC CABLE CONDUIT LINES SHALL BE 4"SCH. 40 PVC CONDUIT UNLESS OTHERWISE INDICATED. THE TELCO CONDUIT FROM THE PPC SHALL BE ROUTED AND TERMINATED AT DESIGNATED TELCO DEMARCATION OR 2-FEET OUTSIDE FENCED AREA, NEAR UTILITY POLE (IN FENCED AREA), OR END CAP OFF AND PROVIDE MARKER STAKE PAINTED BRIGHT ORANGE WITH DESIGNATION FOR TELCO SERVICE.
- CONDUIS INSTALLED AT PCS EQUIPMENT ENDS PRIOR TO THE EQUIPMENT INSTALLATION SHALL BE STUBBED AND CAPPED AT 8 ABOVE GRADE OR PLATFORM. IF SERVICE LINES CAN'T BE INSTALLED INITIALLY, PROVIDE NYLON PULL CORD IN CONDUITS.
- 40. THE VERZON WIRELESS PILC, INCLUDING 200 AMP DUAL INTERLOCKING MAIN CIRCUIT BREAKERS 200A ATS, 200A LOADCENIER PANEL AND TELCO PANEL SHALB E PROVIDED BY OWNER AND INSTALLED BY THE CONTRACTOR, CONTRACTOR SHALL FURNISH AND INSTALL CIRCUIT BREAKER(S) NOT PROVIDED BY MANUFACTURER, SEE PANEL SCHEDULE IN THESE DRAWINGS FOR CIRCUIT BREAKER REQUIREMENTS.









CAPITAL DESIGN SERVICE

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VER.	VER. DATE DESCRIPTION			
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PROJECT INFORMATION

MOSSYROCK

262 SKYVIEW DR MOSSYROCK, WA 98564

SHEET TITLE

GENERAL ELECTRICAL NOTES

SHEET NO.

E5.0

Lewis County Community Development

125 NW Chehalis Ave, Chehalis, WA 98532 ● Phone: (360) 740-1146 ● www.lewiscountywa.gov

Master Site Plan Application

For a complete Master Site Reivew application, you will need:

RECEIVED

• Completed 'Master Site Plan Application'

By Mollie Hurt at 12:08 pm, Mar 03, 2025

- Site plan that includes all items listed on the 'Site Plan Requirements' handout (attached)
- Associated fees: \$450 Master Site Review / \$150 Minor Review Fee (Fee Includes \$50 Administrative Fee)

Full Project Description: Installation of a wireless communication facility consisting of a new 150'
Tax Parcel Number (s):
Site Address: 262 SKYVIEW DR MOSSYROCK, WA 98564
Owner's Name: KEVIN RIFFLE
Owner's Address: 8025 124TH AVE NE KIRKLAND WA 98033
Owner's Name: KEVIN RIFFLE Owner's Address: 8025 124TH AVE NE KIRKLAND WA 98033 Owner's Phone Number: 425-445-4000 Owner's Email: kevinriffle@live.com
Applicant Information:
Name: Bill North, for Harmoni Towers and Verizon Wireless
Mailing Address: PO Box 2449 Snohomish, WA 98291
Phone Number: 425-876-2909 E-mail: billnorth@northgroup.net
Acknowledgment
I understand that County regulations require owner permission for County personnel to enter private property to conduct permit processing, review, and inspections. I also understand that my failure to grant permission to enter may result in denial or withdrawal of a permit or approval. By my signature below, permission is granted for representatives of the Community Development, Environmental Services, and Public Works Department to enter and remain on and about the property for the sole purpose of processing such permits and performing required inspections or reviews.
I/We certify that all plans, specifications and other submissions required in support of this application conform to the requirements of all federal, state, and local codes and applicable laws and ordinances; and I certify that I am either the current legal owner of this property or their authorized representative. With this document, I take full responsibility for the lawful action that this document allows.
I certify that I have read and understand the limitations and conditions of Lewis County Code and agree to comply with all conditions of approval. I understand that any permits issued by Lewis County, consistent with the attached site plan, are valid ONLY if construction is in according to this plan and all other conditions of the permit are followed. By my signature below, I affirm that all the information and documents provided with this application are true and accurate to the best of my knowledge.
Signature: Bill North Digitally signed by Bill North Date: 2025.03.02 12:02:32 -08'00' Date: 3/2/25
Check one: Owner Authorized Agent